

GLAZING NOTES:

- 1. GLAZING IN THE FOLLOWING LOCATIONS SHALL BE SAFETY GLAZING CONFORMING TO HUMAN IMPACT LOADS OF SECTION R308.3 (SEE EXCEPTIONS) (R308.4):
- A) FIXED AND OPERABLE PANELS OF SWINGING, SLIDING AND BI-FOLD DOOR ASSEMBLIES.
- B) GLAZING IN AN INDIVIDUAL FIXED OR OPERABLE PANEL ADJACENT TO A DOOR WHERE THE NEAREST VERTICAL EDGE IS WITHIN A 24-INCH ARC OF THE DOOR IN A CLOSED POSITION WHOSE BOTTOM EDGE IS LESS THAN 60 INCHES ABOVE THE FLOOR OR WALKING SURFACE.
- C) GLAZING IN AN INDIVIDUAL FIXED OR OPERABLE PANEL THAT MEETS ALL OF THE FOLLOWING CONDITIONS:
- 1. EXPOSED AREA OF AN INDIVIDUAL PANE GREATER THAN 9 SQUARE FEET.
 2. BOTTOM EDGE LESS THAN 36 INCHES ABOVE THE FLOOR.
 3. TOP EDGE GREATER THAN 36 INCHES ABOVE THE FLOOR.
 4. ONE OR MORE WALKING SURFACES WITHIN 36 INCHES HORIZONTALLY OF THE GLAZING.
- D) GLAZING IN RAILINGS.
- E) GLAZING IN ENCLOSURES FOR OR FACING HOT TUBS, WHIRLPOOLS, SAUNAS, STEAM ROOMS, BATHTUBS AND SHOWERS WHERE THE BOTTOM EDGE OF THE GLAZING IS LESS THAN 60 INCHES MEASURED VERTICALLY ABOVE ANY STANDING OR WALKING SURFACE.
- F) GLAZING IN WALLS AND FENCES ADJACENT TO INDOOR AND OUTDOOR SWIMMING POOLS, HOT TUBS AND SPAS WHERE THE BOTTOM EDGE OF THE GLAZING IS LESS THAN 60 INCHES ABOVE A WALKING SURFACE AND WITHIN 60 INCHES, MEASURED HORIZONTALLY AND IN A STRAIGHT LINE,
- G) GLAZING ADJACENT TO STAIRWAYS, LANDINGS AND RAMPS WITHIN 36 INCHES HORIZONTALLY OF A WALKING SURFACE WHEN THE GLAZING IS LESS THAN 60 INCHES ABOVE THE PLANE OF THE ADJACENT WALKING SURFACE.
- H) GLAZING ADJACENT TO STAIRWAYS WITHIN 60 INCHES HORIZONTALLY OF THE BOTTOM TREAD OF A STAIRWAY IN ANY DIRECTION WHEN THE EXPOSED SURFACE OF THE GLAZING IS LESS THAN 60 INCHES ABOVE THE NOSE OF THE TREAD.

WINDOW SCHEDULE												
WINDOW	WIDTH x HEIGHT	SILL HT.	QTY.	MFTR.	MODEL	TYPE	GLAZING	FRAME MATERIAL	REMARKS			
A	6'-10" X 3'-10"	3'-0"	1	JACK'S	JACK'S	FIXED	DUAL LOW-E	ALUMINUM	BLACK ANODIZED			
B	7'-9" X3'-10"	2'-2"	1			FIXED, MITERED CORNER	1/4" CLEAR LAMINATED	N/A	FRAMELESS			
(c)	5'-0" X 3'-10"	2'-2"	1			MITERED CORNER	1/4" CLEAR LAMINATED	N/A	FRAMELESS			
D	1'-8" X 6'-4"	0'-0"	1			AWNING	DUAL LOW-E TEMPERED	ALUMINUM	BLACK ANODIZED			
E	6'-6" X 8'-8"	2'-2"	1			FIXED	1/4" CLEAR LAMINATED	N/A	FRAMELESS			
F	2'-0" X 4'-6"	2'-2"	1			AWNING	DUAL LOW-E	ALUMINUM	BLACK ANODIZED			
G	5'-3" X 3'-0"	3'-8"	1			AWNING	DUAL LOW-E	ALUMINUM	BLACK ANODIZED			
H	2'-6" X 4'-6"	2'-2"	1			AWNING	DUAL LOW-E	ALUMINUM	BLACK ANODIZED			
	2'-6" X 4'-6"	2'-2"	1			AWNING	DUAL LOW-E	ALUMINUM	BLACK ANODIZED			
J	1'-7" X 2'-7"	4'-0"	1	▼	V	AWNING	DUAL LOW-E	ALUMINUM	BLACK ANODIZED, IN (E) OPENING			
⟨K⟩	6'-0" X 6'-0"	N/A	2	SUN VALL SKYLIGHT	EY S	OPERABLE ON MOTOR	DUAL PLASTIC	ALUMINUM	BLACK ANODIZED			
(L)	6'-8" X 1'-0"	0'-0"	1	JACK'S	JACK'S	FIXED SIDELIGHT	1/4" CLEAR LAMINATED	N/A	FRAMELESS, AT FRONT DOOR			

DOOR SCHEDULE												
DOOR	WIDTH	HEIGHT	THK	QTY	TYPE	THRES.	MATERIAL	MFTR.	GLAZING	HARDWARE	REMARKS	
1	3'-0"	6'-10"	1/2"	1	SWING	YES		HERCULITE	1/2" CLEAR TEMPERED	EXISTING FLOOR LOCK & OVERHEAD HINGE	REUSE (E) HERCULITE DOOR	
2	8'-0"	8'-0"	2"	1	XXX SLIDER	NO	ALUMINUM		1/4" CLEAR TEMPERED			
3	3'-0"	6'-8"	1 3/4"	1	SWING	NO	SOLID CORE INTERIOR WOOD		NONE			
4	6'-0"	6'-8"	1 3/4"	1	PAIR SWING	YES	HOLLOW CORE EXTERIOR STEEL		NONE			

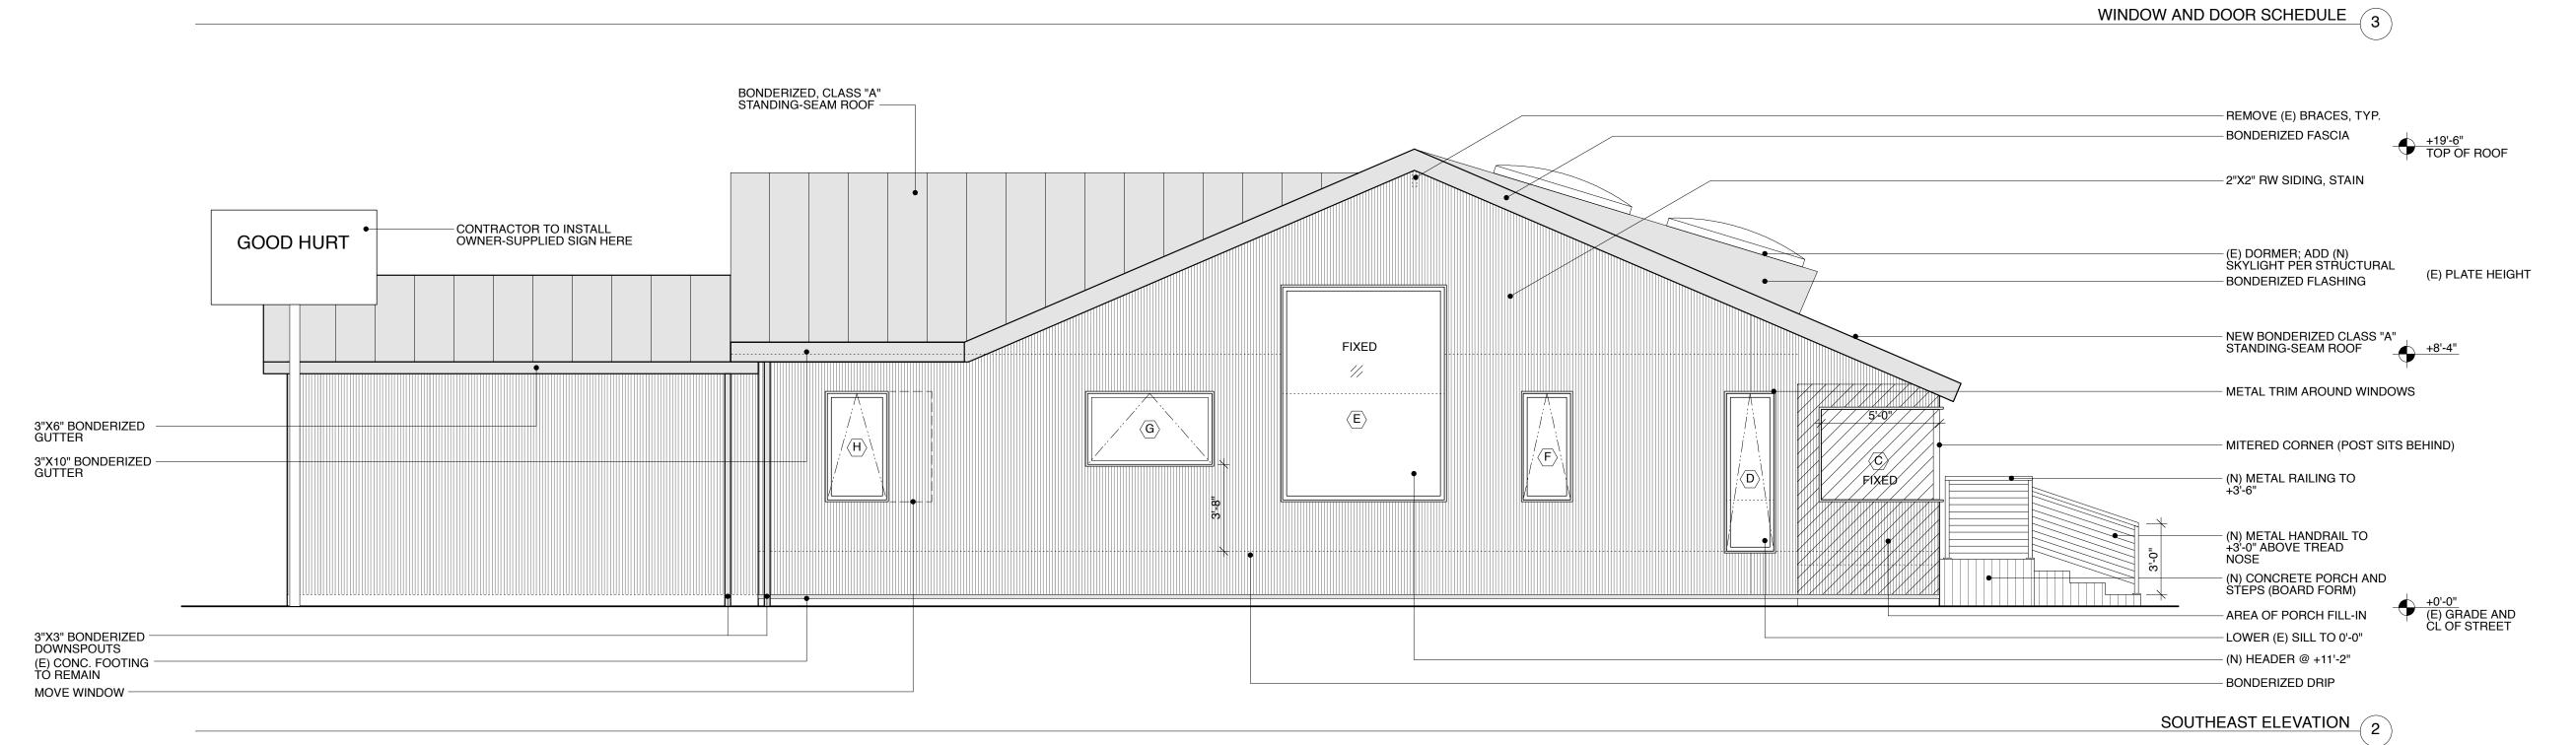

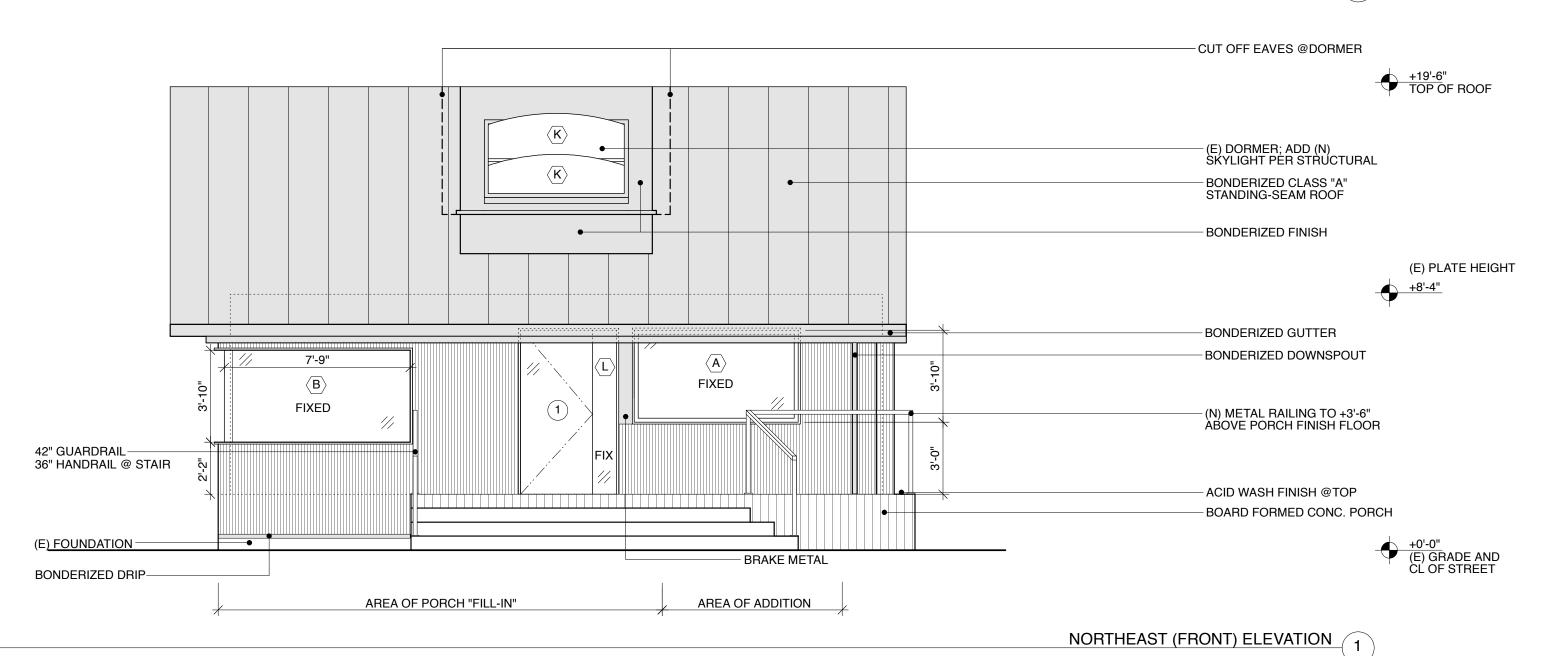

PROJECT: 1524 ABBOT KINNEY

ARCHITECT:



DesignUniversal

ARCHITECTURE AND DESIGN

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 REVISION / ISSUE:
 DATE:

 1. PRELIM DESIGN
 10/24/2011

 2. SUBMITTAL SET
 12/16/2011

 3. PLAN CHECK CORR.
 1/11/2012

 4. REVISED BID SET
 1/13/2012

 5. CONSTRUCTION SET
 2/13/2012

 6. REV. CONSTRUCTION SET
 2/22/2012

EXTERIOR ELEVATIONS

DATE: DRAWN: SCALE: 10/24/2011 MAA 1/4" = 1'-0"

A-2₋0