## GENERAL NOTES

- 1. These construction documents have been prepared based on the requirement of all applicable local and state building codes, ordinances, and regulations.
- 2. Contractor shall have current workers' compensation insurance coverage in compliance with Section 3800 of the California Labor Code, on file with the state control board.
- 3. All work, construction, and materials shall comply with all provisions of the building code and with other rules, regulations and
- ordinances governing the place of building.

  4. Building code requirements take precedence over the drawings and it shall be the responsibility of anyone supplying labor or materials or both to bring to the attention of the architect any discrepancies or conflict between the requirements of the code and the
- 5. The contract structural drawings and specifications represent the finished structure. They do not indicate the means or method of construction. The subcontractor shall provide all measures necessary to protect the structure during construction. Such measures shall include, but not be limited to, bracing, shoring for loads due too construction equipment, etc. Contractor shall provide plans and permits for temporary shoring of excavations that remove the lateral support from a public way or an existing building or structure. Observation visits to the site by the architect shall not include inspection of the above items.
- 6. In preparing a proposal, the contractor shall have visited the site, carefully examined the drawings and the methods of removal and storage of materials, the sequencing of operation, and the problems attendant thereto. No allowance will be made to the contractor for any error through negligence in observing the site condition.
- 7. Architect shall be notified immediately by the contractor should any discrepancy or other questions arise pertaining to the working drawings. Work shall not commence until clarifications are obtained from the architect.8. On-site verification of all dimensions and conditions shall be the responsibility of the contractor. Site conditions in conflict with the
- expressed dimensions herein shall be brought to the attention of the architect for consideration and new alignments may be established only with the written approval and acceptance of the architect.
- 9. Dimensions shall take precedence over scales shown on the drawings. **Do not scale drawings.** Large scale details govern over small scale details.
- 10. All dimensions are to the face of finish unless otherwise noted. All work shall be erected plumb, level, and true in accordance with the details.
- 11. Notes and details on drawings shall take precedence over general notes and typical details. Where no details are shown, construction shall conform to similar work on the project.
- 12. Provide temporary sanitary facilities for workmen's use per the local building department regulations.
- 13. Construction materials shall be spread out if placed on framed floors or roof. Load shall not exceed the design live load per square foot. Contractor shall provide adequate shoring and/or bracing where structure has not attained design strength.
- 14. No deviation from the structural design without written approval of the structural engineer and building department authority to deviate from the plans or specifications.15. All material stored on the site shall be stacked neatly on skids, platforms or blocking "high and dry" protected as recommended by
- 16. All equipment, hardware, and other items shall be supplied as specified, unless changes are reviewed and accepted by both owner and architect. If changes are required for any reason to comply with the design intent, contractor shall notify architect immediately with
- recommendation of remedial course of action.

  17. Contractor shall notify utility companies prior to excavating for utilities and shall be responsible for locating all underground
- construction prior to excávation. Contractor shall notify owner and architect of any conditions found.

  18. The contractor shall provide all necessary blocking, backing, framing, hangers or other support for all fixtures, equipment and
- cabinetry.

  19. Regulations, Taxes, and Permits
- The whole of the work shall be executed in strict accordance with the regulations and codes of the governmental agencies whose jurisdiction is applicable. The owner shall pay for plan checking and building permits. Each sub-contractor shall satisfy local permit, license, insurance and safety requirements and shall be responsible for the job inspections pertaining to his/her trade. All applicable sales taxes shall be included in contract. Sub contractor shall obtain and pay for all permits pertaining to his/her trade.
- Contractor shall submit 3 copies of required shop drawings, calculations of fabricated products, and 5 copies of manufacturer's catalog sheets, brochures, color samples, installation instructions, etc. on manufactured products used or installed for the project owner's acceptance. The architect's approval of submittals and shop drawings shall not relieve the contractor from the responsibility.
- for deviations from drawings or specifications unless he/she has, in writing, called the architect's attention to such deviations at the time of submissions; nor shall the contractor be relieved from responsibility for errors of any sort in the shop drawings.

  21. Supply new, purely unadulterated, first line quality manufactured materials shipped to job site in original containers with the manufacturer's label showing exact type, size grade, weight, and use. Store in manner consistent with manufacturer's

## 22. Workmanship

sidewalks, and existing utilities shall be included in the requirement.

the manufacturers from potential damage and deterioration caused by the elements

## Shall be of the highest quality and done by skilled employees in the practice of their trade. 23. Responsibility of Subcontractors

- A. Each subcontractor shall at all times be fully aware of the job progress to allow himself/herself ample lead time to commence each
- B. Subcontractors shall thoroughly inspect adjacent work that may impact installation of their trade and notify general contractor, in writing, of any irregularities. Commencing work constitutes acceptance of conditions and therefore responsibility for and rectification
- any resulting, unsatisfactory work.

  C. Materials and the work of others shall be inspected by each trade prior to the commencement of his/her particular standard as herein described, shall be replaced by the subcontractor at the subcontractor's sole expense including the work of others damaged by initial failure or corrective repairs. The inability of the general contractor, or his/her representative, to notice omitted or faulty materials or workmanship during construction shall not constitute a release from these requirements of subcontractor. If work is considered to be

substandard, the work shall be tested as is standard to that industry. If the work fails to meet the testing standards, subcontractor shall

- pay for the testing and the replacement of the work. If the work passes the test the owner pays for the test and repair of said work.

  D. Each subcontractor shall maintain adequate protection of all his/her work from damage and shall protect the owner's and other trades' work and property from damage or injury while fulfilling his/her contract. All materials, work in place, finishes, paying and
- E. Structure and contents shall be protected from the inclemencies of weather during the term of the work.
- F. In the event subcontractors' work is damaged by other trades, it will be the subcontractor's obligation to resolve the cost of repairs of said damage with responsible subcontractors. the general contractor shall have the power of final arbitration in these matters.

  G. Each trade shall cooperate fully, both with the general contractor's superintendent and other trades, and consult with other trades (in writing, if need be), in order to "can out," allow passage, provide protection or do work necessary to allow others to follow in an order to "can out," allow passage, provide protection or do work necessary to allow others to follow in an order to "can out," allow passage, provide protection or do work necessary to allow others to follow in an order to "can out," allow passage, provide protection or do work necessary to allow others to follow in an order to "can out," allow passage, provide protection or do work necessary to allow others to follow in an order to "can out," allow passage, provide protection or do work necessary to allow others to follow in an order to "can out," allow passage, provide protection or do work necessary to allow others to follow in an order to "can out," allow passage, provide protection or do work necessary to allow others to follow the protection or do work necessary to allow others to follow the protection or do work necessary to allow others to follow the protection or do work necessary to allow others to follow or the protection or do work necessary to allow others to follow the protection or do work necessary to allow others to follow the protection or do work necessary to allow others to follow the protection or do work necessary to allow others to follow the protection or do work necessary to allow others to follow the protection or do work necessary to allow others to follow the protection or do work necessary to all the protection of the protection or do work necessary to all the protection of the protection or do work necessary to all the protection of the protection or
- H. All materials and appliances shall be uncrated by subcontractor responsible for installation, unless otherwise specified in contract.

  24. Work, Authorization, and Payments
- All work done or materials used shall be covered by a contract, contract change order, purchase order, or work order. No invoice will be processed unless it lists the contract, purchase order, work order, or change order number.
- 25. <u>Clean-up</u>

  The contractor shall clean and remove from the site any debris and unused materials. Unused materials, equipment, scaffolding, and debris shall be removed from the site at completion. Final cleaning shall include: removal of all grease, dust, stains, labels, fingerprints paint spots from the site, and exposed interior and exterior finish surfaces; polish surfaces so designated to shine finish; and repair, patch or touch up, or replace marred surfaces to specified finish, or to match adjacent surfaces.

## SUPPLEMENTAL NOTES

- 1. General conditions of the contract for construction will be those agreed upon by and between the owner and the contractor. However, for the purpose of compiling these specifications, it has been assumed that the general conditions will be those contained in the AIA Document A111, a copy of which is on file at the office of the architect.
- 2. Should errors, omissions, or discrepancies appear in drawings or specification, or in the work done by others affecting this work, the architect shall be notified at once and will issue instructions as to procedure.
- 3. The contractor shall conform to and abide by all local, city, county, and state building and safety laws. Such laws shall be considered as part of these specifications and the provisions of such regulations shall be observed. The contractor shall notify the architect if drawings or specifications are at variance. Should the contractor perform any work contrary to such laws, or regulations, he/she shall bear all costs arising.
- Named products make no guarantees for products identified by trade name or manufacturer.
- 5. The contractor shall review all documents related to this project for errors, omissions, and discrepancies prior to the start of construction. The contractor shall arrange a pre-construction meeting to review errors, omissions and discrepancies prior to the performance of any work.
- 6. The builder shall provide the owner a list of the heating, cooling, water heating, and warranty manuals, and lighting systems, and conservation or solar devices installed in the building and instructions on how to use them efficiently.
  7. After installing insulation, the installer shall post in a conspicuous location in the building a certificate signed by the installer and the builder stating that the installation conforms with the requirements of Title 24, part 2, Chapter 2-53, and that materials installed conform with the requirements of Title 20, Chapter 2. The certificate shall state the manufacture's name and material identification, the installed
- R-value, and weight per square foot.

  8 The contractor shall provide a fire protection system during construction and maintain insurance
- 8. The contractor shall provide a fire protection system during construction and maintain insurance.9. The contractor shall protect trees and shrubs as indicated to remain by providing a fence around the tree or shrub of sufficient distance away and of sufficient height so that trees and shrubs shall not be damaged in any way. Contractor shall be responsible for any damage which may occur.
- 10. Contractor shall provide sprinkler system as required by code. Sprinkler system to be approved by the plumbing division prior to installation. Selection and location of sprinkler heads to be approved by architect prior to installation.
- 11. Provide plans for temporarily storing of excavations that remove the lateral support from a public way or an existing building. Excavation adjacent to a public way require public works approval prior to issuance of building permit.
- 12. There shall be no trenches or excavations 5' or more in depth into which a person is required to descend or the contractor must obtain a necessary permit from the State of California Division of Industrial Safety prior to the issuance of a building or grading permit.

## ADDITIONAL NOTES

- 1. These drawings shall remain the property of the design professional. Copies of the drawings and specifications retained by the client may be utilized only for his or her use and for occupying the project for which they were prepared, and may not be used for the construction of any other project.
- 2. These drawings, specifications and other documents prepared by the architect for this project are instruments of the architect's service for use solely with respect to this project, and unless otherwise provided, the architect shall be deemed the author of these
- documents and shall retain all common law, statutory and other reserved rights, including the copyright.

  3. All construction fabrication, and installations shall conform to the latest adopted editions of the UBC, UFC, UPC, NEC and any federal, state or local codes, regulations or ordinances of the governing agency having jurisdiction over this project. Such applicable codes etc. are those in effect at the time the permit application for the project is recorded.
- 4. The interior finishes shall comply with UFC appendix V1-C and UBC chapter 8.5. All work performed and materials used shall be of the same standard of quality as that of the existing finished building as a minimum unless noted or scheduled otherwise.
- 6. Verify that services to be removed or abandoned have been properly and safely shut off, capped, or sealed
- 7. Verify hours of work with landlord. Keep noise and vibration to a minimum. If performing any core drilling or similar activities, perform work in a safe manner in accordance with landlord's requirements, OSHA, state or federal guidelines, . Protect space below from water damage or damage from falling debris
- 8. Provide ceiling access panels as required to allow for service of or adjustment to any valves or mechanical items as required. Access panels to be flush with ceiling and painted to match ceiling. Provide rated access panels in rated ceiling equal to the level of protection as that of the ceiling.

- 9. Drywall contractor to carefully study the architectural and interiors drawings and provide 20 ga. backing where required for attachment of all items to be wall mounted.

  CONSTRUCTION NOTES:
- Construction to comply with all local, state, and national codes.
- 2. All dimensions are shown to face of finish u.o.n.
- 3. Contractor shall field verify all dimensions, notify architect immediately of any and all dimensional discrepencies before proceeding with work.
- 4. All plumbing, electric, and hvac fixtures and equipment to be city of la approved and installed according to applicable codes. Plumbing fixtures are required to be connected to a sanitary sewer or an approved sewage disposal system.
- 5. Provide ultra flush water closets for new construction. Existing shower heads and toilets must be adapted for low water consumption. New toilets to be 1.28 ga. or less.6. Glazing used for shower doors / bath enclosures to be tempered saftey glass and shall pass ubc standard no. 54-2 and comply with
- 7. Provide 70" min. high non absorbant wall adjacent to shower and approved shatter-resistant materials for shower enclosure.
  8. Every space intended for human occupancy shall be provided with natural light by means of exterior glazed openings in accordance with Section R303.1 or shall be provided with artificial light that is adequate to provide an average illumination of 6-foot candles over the area of
- the room at a height of 30 inches above the floor lever.

  9. Damp proof all walls and foundations below grade. dampproofing where required, shall be installed with materials and as required in section R406.1
- 10. An approved seismic gas shut off valve will be installed on the fuel gas line on the down stream side of the utility meter and be rigidly connected to the exterior of the building or structure containing the fuel gas piping per ordinance 171,874 for work over \$10,000. Separate permit is required.
- 11. Water heater must be strapped to wall.

  12. The construction shall not restrict a five-foot clear and unobstructed access to any water or power distribution facilities (power poles, pull-boxes, transformers, youlds, pumps, values, meters, apput prances, etc.) or to the location of the book-up. The construction shall no
- pull-boxes, transformers, vaults, pumps, valves, meters, appurtenances, etc.) or to the location of the hook-up. The construction shall not be within ten feet of any power lines-whether or not the lines are located on the property. Failure to comply may cause construction delays and/or additional expenses.

  13. No protected tree shall be relocated or removed without the approval from the Board of Public Works.
- 14. In new construction smoke alams shall receive their primary power source from the building wiring and shall be equipped with battery back up and low battery signal. Smoke alarms shall be located in each sleeping room and hallway or area giving access to a sleeping room, and on each story and basement for dwellings with more than one story. Smoke alarms shall be interconnected so that actuation of one alarm will activate all the alarms within the individual dwelling unit.
- 15. Bathtub and shower floors, walls above bathtubs with a showerhead, and shower compartments shall be finished with a nonabsorbent surface. Such wall surfaces shall extend to a height of not less than 6 feet above the floor.
- 16. Kitchen sinks, lavatories, bathtubs, showers, bidets, laundry tubs and washing machine outlets shall be provided with hot and cold water and connected to an approved water supply.
- 17. Where a permit is required for alterations, repairs or additions exceeding one thousand dollars (\$1,000), existing dwellings or sleeping units that have attached garages or fuel burning appliances shall be provided with a carbon monoxide alarm in accordance with Section R315.1. Carbon monoxide alarms shall only be required in the specific dwelling unit or sleeping unit for which the permit is obtained.
- 18. Lots shall be graded to drain surface water away from foundation walls with a minimum fall of 6 inches within the first 10 feet.

  19. A copy of the evaluation report and/or conditions of listing shall be made available at the job site.
- 20. Smoke detectors shall be provided for all dwelling units intended for human occupancy, upon the owner's application for permit for alterations, repairs, or additions, exceeding one thousand dollars (\$1,000).21. Automatic garage door openers, if provided, shall be listed in accordance with UL 325.
- 22. Bathrooms, water closet compartments and other similar rooms shall be provided natural ventilation or with mechanical ventilation capable of 50 cfm exhausted directly to the outside.
- 23. Heater shall be capable of maintaining a minimum roof temperature of 68 degrees F at a point 3 feet above the floor and 2 feet from exterior walls in all habitable rooms at the design temperature.
  24. Protection of wood and wood based products from decay shall be provided in the locations specifiedper section R317.1 by the use of naturally durable wood or wood that is preservative-treated in accordance with AWPA U1 for the species, product, preservative and end
- use. Preservatives shall be listed in Section 4 of AWPA U1.25. Buildings shall have approved address numbers, building numbers or approved building identification.
- 26. All interior and exterior stairways shall be illuminated.

buidling wiring and shall be equipped with battery back-up and low battery signal.

5. Vehicular access doors shall comply with Section R609.4.

- 27. The flow rates for all new plumbing fixtures shall comply with the maximum flow rates specified in section 4.303.1
- FIRE PROTECTION

  1. Smoke detectors shall be provided in each sleeping room, on the ceiling of wall immediately outside of each sleeping room, and on each story and basement for dwellings with more than one story.
- The power source for smoke detectors shall be as follows;
   a. In new construction smoke detectors shall receive their primary power from the building wiring and shall be equipped with a
- battery backup.

  b. In existing SFD, smoke detectors may be battery operated.
  c. Carbon monoxide alarm is required per Sec. 420.5
- Through penetrations of fire-resistance-rated wall or floor assemblies shall comply with Section R302.4.1.1 or R302.4.1.2. Provide detail and copy of listing on plans.
   Membrane penetrations shall comply with Section R302.4.1. Where walls are required to have a fire-resistance rating recessed fixtures shall be installed so that the required fire-resistance rating will not be reduced. R302.4.2.
- 5. In combustible construction, fire blocking shall be provided to cut off all concealed draft openings (both vertical and horizontal) and to form an effective fire barrier between stories, and between a top story and the roof space.6. The building shall be equipped with an automatic residential fire sprinkler system in accordance with Section R313.3 or NFPA13D.
- 7. Sprinkler will be approved by Plumbing Divisions prior to installation.


  8. An approved smoke alarm shall be intalled in each sleeping room & hallway or area giving access to a sleeping room and on each story and basement for dwellings with more than one story. Smoke alarms shall be interconnected so that actuation of one alarm will activate all the alarms within the individual dwelling unit. In new construction smoke alarams shall receive their primary source of power from the
- 9. An approved carbon monoxide alarm shall be installed in dwelling units and in sleeping units within which fuel-burning appliances are installed and in dwelling units that have attached garage. Carbon monoxide alarm shall be provided outside of each separate dwelling unit sleeping area in the immediate vicinity of the bedroom(s) and on every level of a dwelling unit including basements. R315
- GENERAL REQUIREMENTS

  1. Ducts penetrating the walls or ceilings seperating the dwelling from the garage shall be constructed of a minimum No. 26 gage sheet steel or other approved material and shall not have openings into the garage.
- Other pentrations of garage/dwelling ceilings and walls shall eb protected as required by Section R302.11, Item 4.
   Garage floor surfaces shall be of an approved non combustible material, and the area used to park vehicles shall be sloped to a drain or toward the main vehicle entry doorway.
   Heater shall be capable of maintaining a minimum room temperature of 68F at a point 3 feet above the floor and 2 feet from exterior walls in all habitable rooms at the design temperature. R303.10.

# NOTES 6

# 2818 CLUNE AVE. | Court | Cou

# VICINITY MAP 5

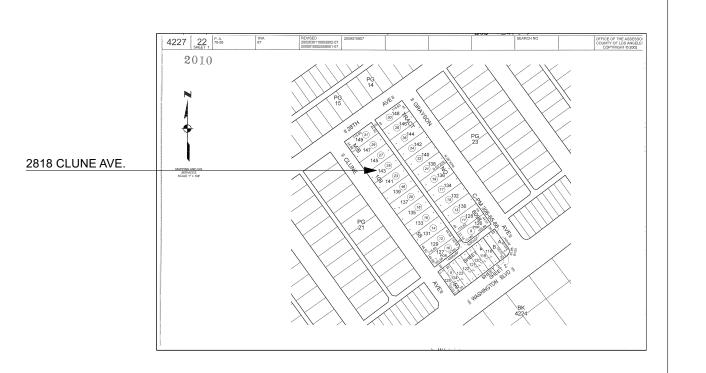

## LOCATION MAP NTS


A-0.0 TITLE SHEET
A-1.1 PROPOSED FLOOR PLAN (SFD)
A-1.2 ROOF PLAN (SFD)
A-1.3 PROPOSED FLOOR PLAN (ADU)
A-1.4 ROOF PLAN (ADU)
A-2.0 EXTERIOR ELEVATIONS (SFD)
A-2.1 EXTERIOR ELEVATIONS (SFD)
A-2.2 EXTERIOR ELEVATIONS (ADU)

SECTIONS (SFD)


SECTIONS (ADU)

A-3.1

# SHEET INDEX 3

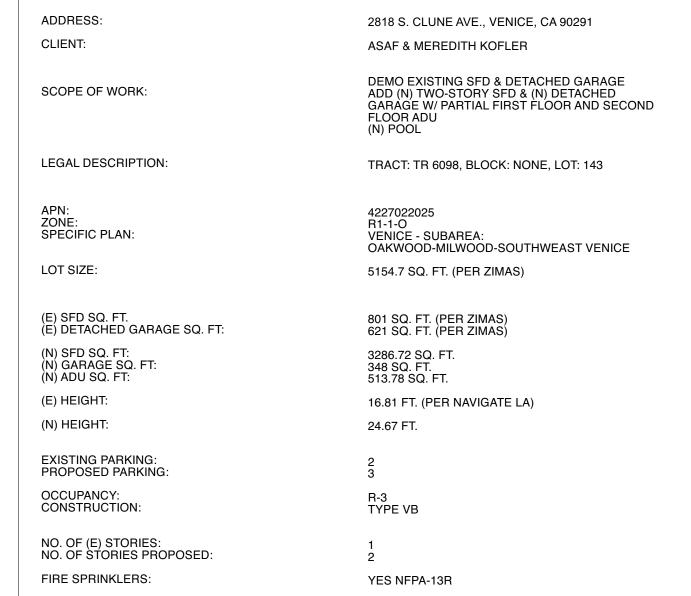

PROJECT DATA 2

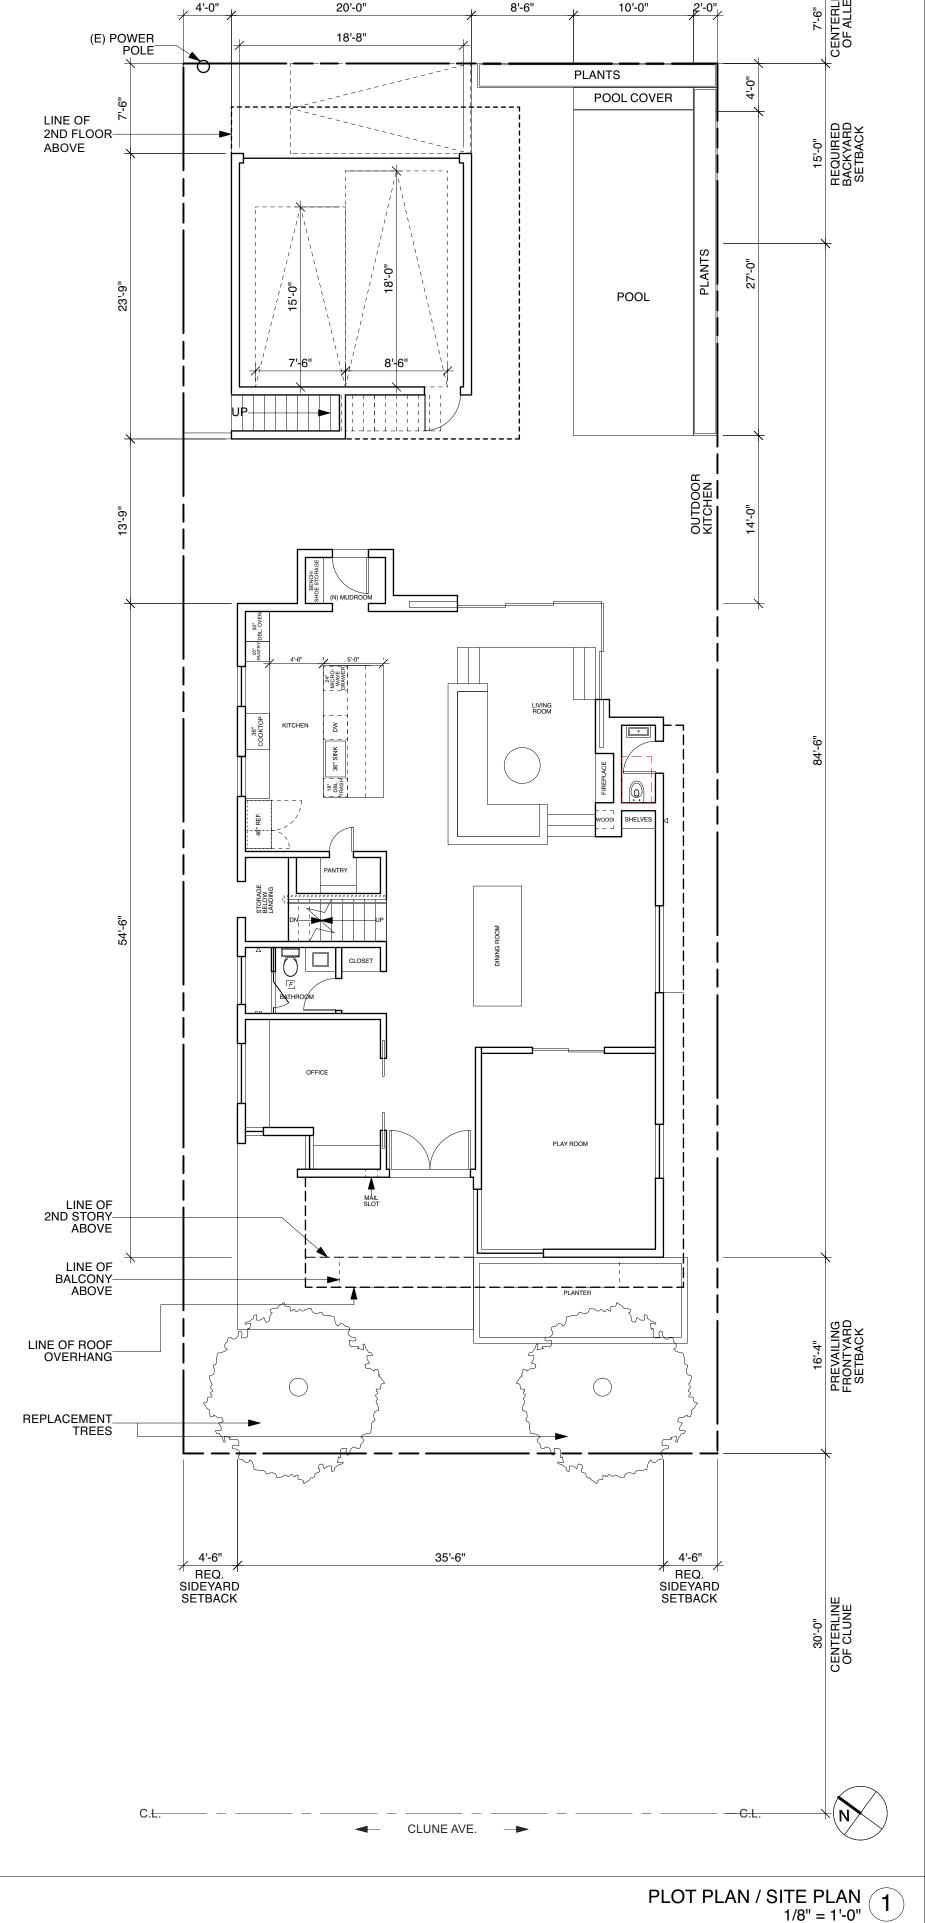

ALLEY

PROJECT:

2818 S. CLUNE AVE.
VENICE, CA 90291

ARCHITECT:



DesignUniversal

ARCHITECTURE AND DESIGN

ROBERT THIBODEAU

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FX: 310.452.8171

OWNER:

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STRUCTURAL ENGINEER:

ASAF@KOFLERDESIGNBUILD.COM

SURVEYOR:

<u>TITLE 24:</u>

CONTRACTOR:

REVISION / ISSUE: DATE:

1. PRELIM DESIGN 12.02.2021

TITLE SHEET

DATE: DRAWN: 12.02.2021 BMK

A-0.0


SCALE:



[\_\_\_\_] DEMO WALLS

ENERGY STAR EXHAUST FAN W/ ACCESSIBLE HUMIDISTAT (50 CFM MIN) TERMINATED TO THE OUTSIDE

□ DOWNSPOUT

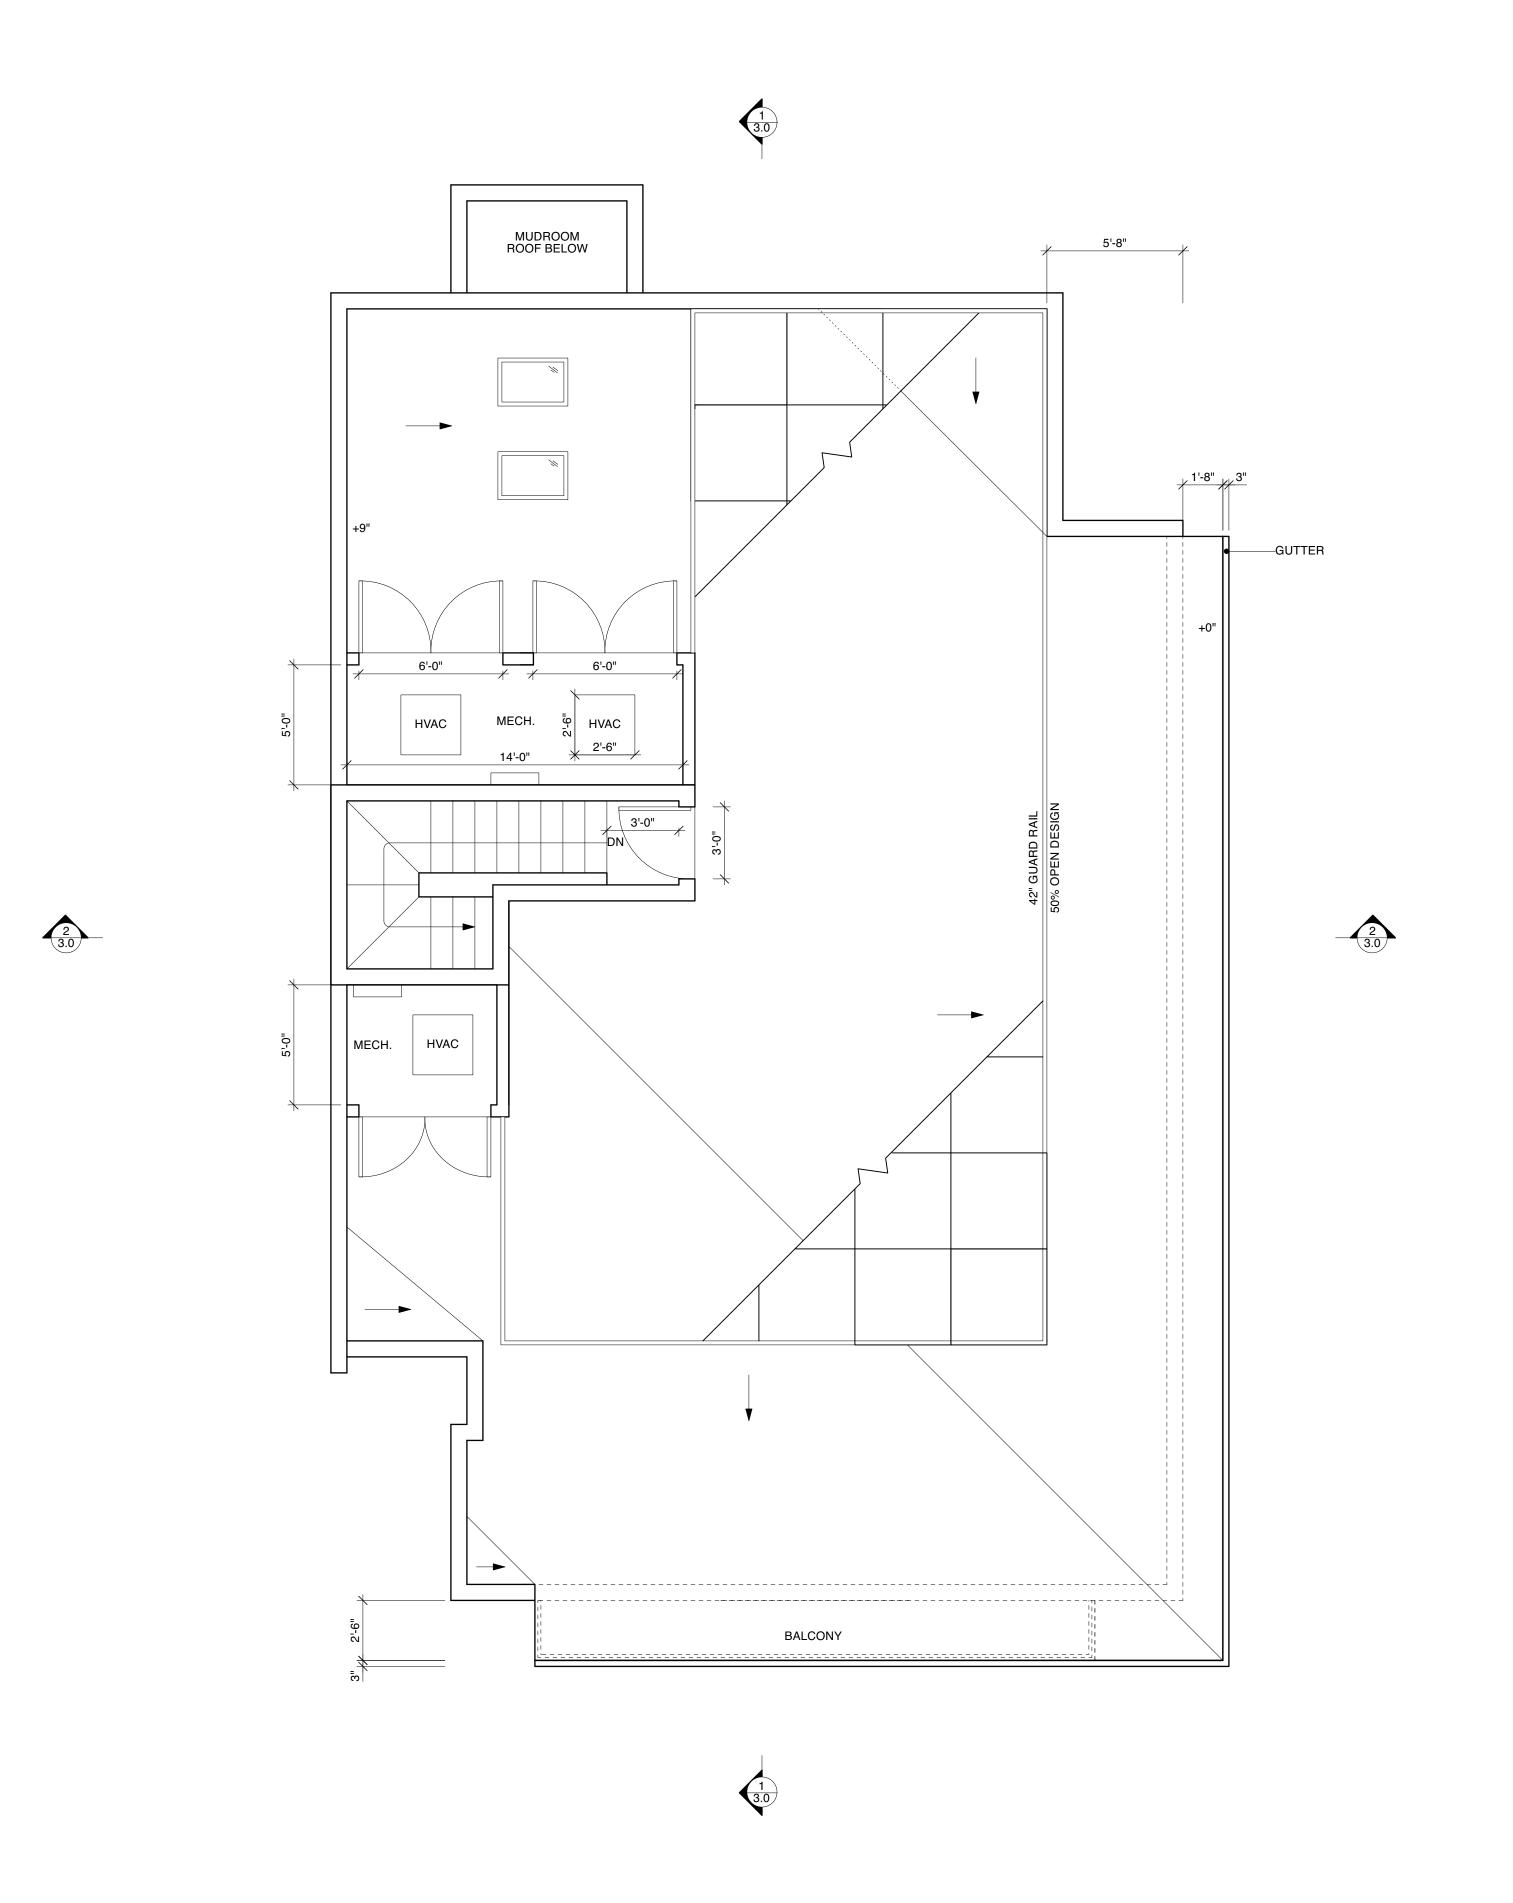

2818 S. CLUNE AVE.
VENICE, CA 90291

ARCHITECT:



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ARCHITECTURE AND DESIGN

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STRUCTURAL ENGINEER:

SURVEYOR:

<u>TITLE 24:</u>

CONTRACTOR:

REVISION / ISSUE: DATE:

1. PRELIM DESIGN 12.02.2021

ROOF PLAN (SFD)

DATE: DRAWN 12.02.2021 BMK

1/4" = 1'-0"

ND (N) WALLS

(N) WALLS 1-HR RATED FIRE WALLS

(N) WALL MOUNTED COMBINATION SMOKE AND CARBON MONOXIDE ALARM

(N) WALLS 1-HR RATED FIRE WALLS

(N) WALL TYPE (SEE A-8.0 FOR DETAIL)

(N) WALLTYPE (SEE A-8.0 FOR DETAIL)

(N) WALLS 1-HR RATED FIRE WALLS

(N) WALLS 1-HR RATED FIRE WALLS

(N) WALL MOUNTED COMBINATION SMOKE ALARM

(N) WALL MOUNTED COMBINATION SMOKE ALARM

(N) WALL MOUNTED COMBINATION SMOKE ALARM

(N) WALLS 1-HR RATED FIRE WALLS

(N) WALLS 1-HR RATED





DesignUniversal

ARCHITECTURE AND DESIGN

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OWNER:

**SURVEYOR:** 

**TITLE 24:** 

**CONTRACTOR:** 


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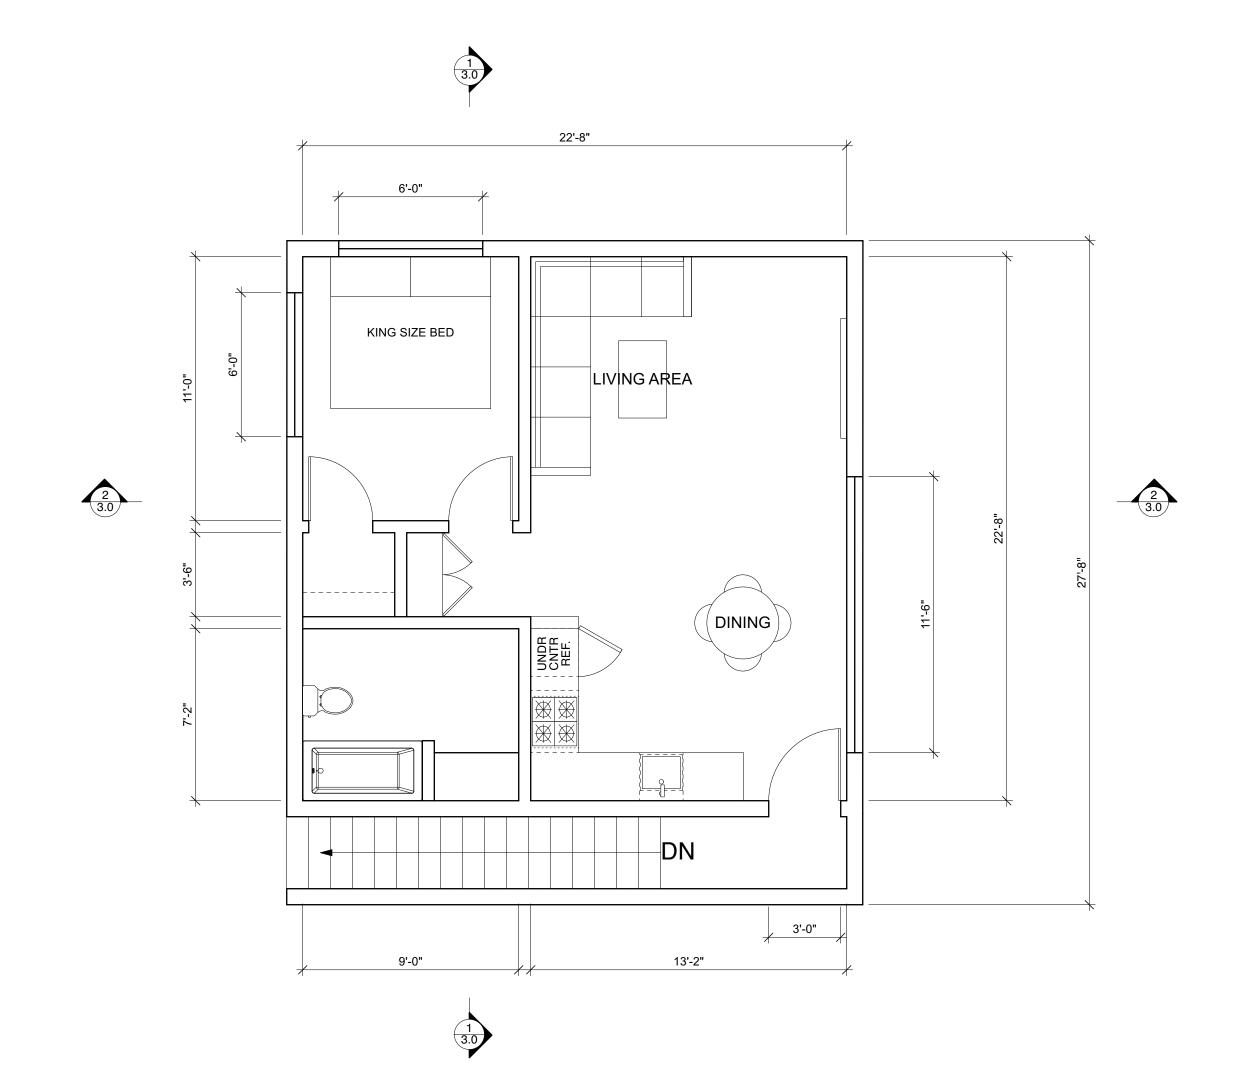
1. PRELIM DESIGN

12.02.2021

ASAF KOFLER
4500 GRIFFIN AVE.
LOS ANGELES, CA 90031
PH: 818.212.0733
EMAIL:
ASAF@KOFLERDESIGNBUILD.COM

STRUCTURAL ENGINEER:



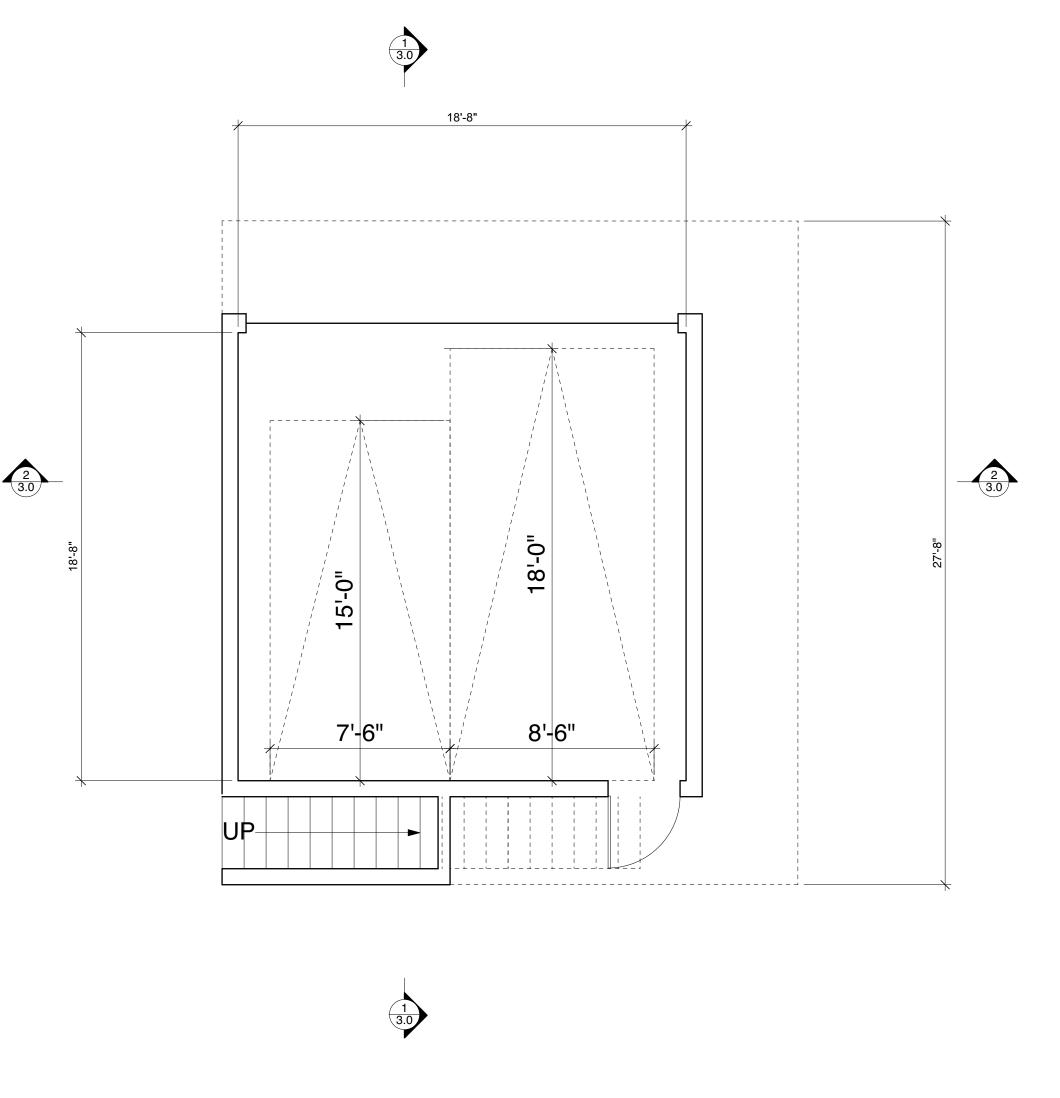

PROPOSED SECOND FLOOR PLAN
Scale: 1/4" = 1'-0" 2

LEGEND

PROPOSED FIRST FLOOR PLAN
Scale: 1/4" = 1'-0"

1

DATE: DRAWN: 12.02.2021 BMK

A-1.3

FIRST & SECOND FLOOR (ADU)

	(N) WALLS 1-HR RATED FIRE WALLS	1	DETAIL MARKER	D A B	INT ELEV MARKER	•	WALL MOUNTED COMBINATION SMOKE AND CARBON MONOXIDE ALARM	+	HOSE BIB	FLOOR INLET FOR CENTRAL VAC	
[	DEMO WALLS	1	SECTION MARKER	<	WALL TYPE (SEE A-8.0 FOR DETAIL)	[F]	ENERGY STAR EXHAUST FAN W/ ACCESSIBLE HUMIDISTAT (50 CFM MIN) TERMINATED TO THE OUTSIDE	⊠ d.s.	DOWNSPOUT		N

ARCHITECT:



DesignUniversal

ARCHITECTURE AND DESIGN

ROBERT THIBODEAU 812 LINCOLN BLVD. VENICE, CA 90291

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OWNER:

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STRUCTURAL ENGINEER:

SURVEYOR:

<u>TITLE 24:</u>

—PARAPET

SCUPPER WITH
OVERFLOW &
DOWNSPOUT
TO RAIN BARREL

CONTRACTOR:

1. PRELIM DESIGN 12.02.2021

REVISION / ISSUE:


ROOF PLAN (ADU)

DATE: 12.02.2021 DRAWN: SCALE: BMK 1/4" = 1'-

Λ 4



LEGEND	(N) WALLS (N) WALLS 1-HR RATED FIRE WALLS	1 DETAIL MARK	$ \begin{array}{ccc} & & & & \\ & & & \\ & $	INT ELEV MARKER	<b>(</b>	WALL MOUNTED COMBINATION SMOKE AND CARBON MONOXIDE ALARM	#	HOSE BIB	FLOOR INLET FOR CENTRAL VAC	
	[] DEMO WALLS	SECTION MAR	KER (1)	WALL TYPE (SEE A-8.0 FOR DETAIL)	F	ENERGY STAR EXHAUST FAN W/ ACCESSIBLE HUMIDISTAT (50 CFM MIN) TERMINATED TO THE OUTSIDE	⊠ D.S.	DOWNSPOUT		

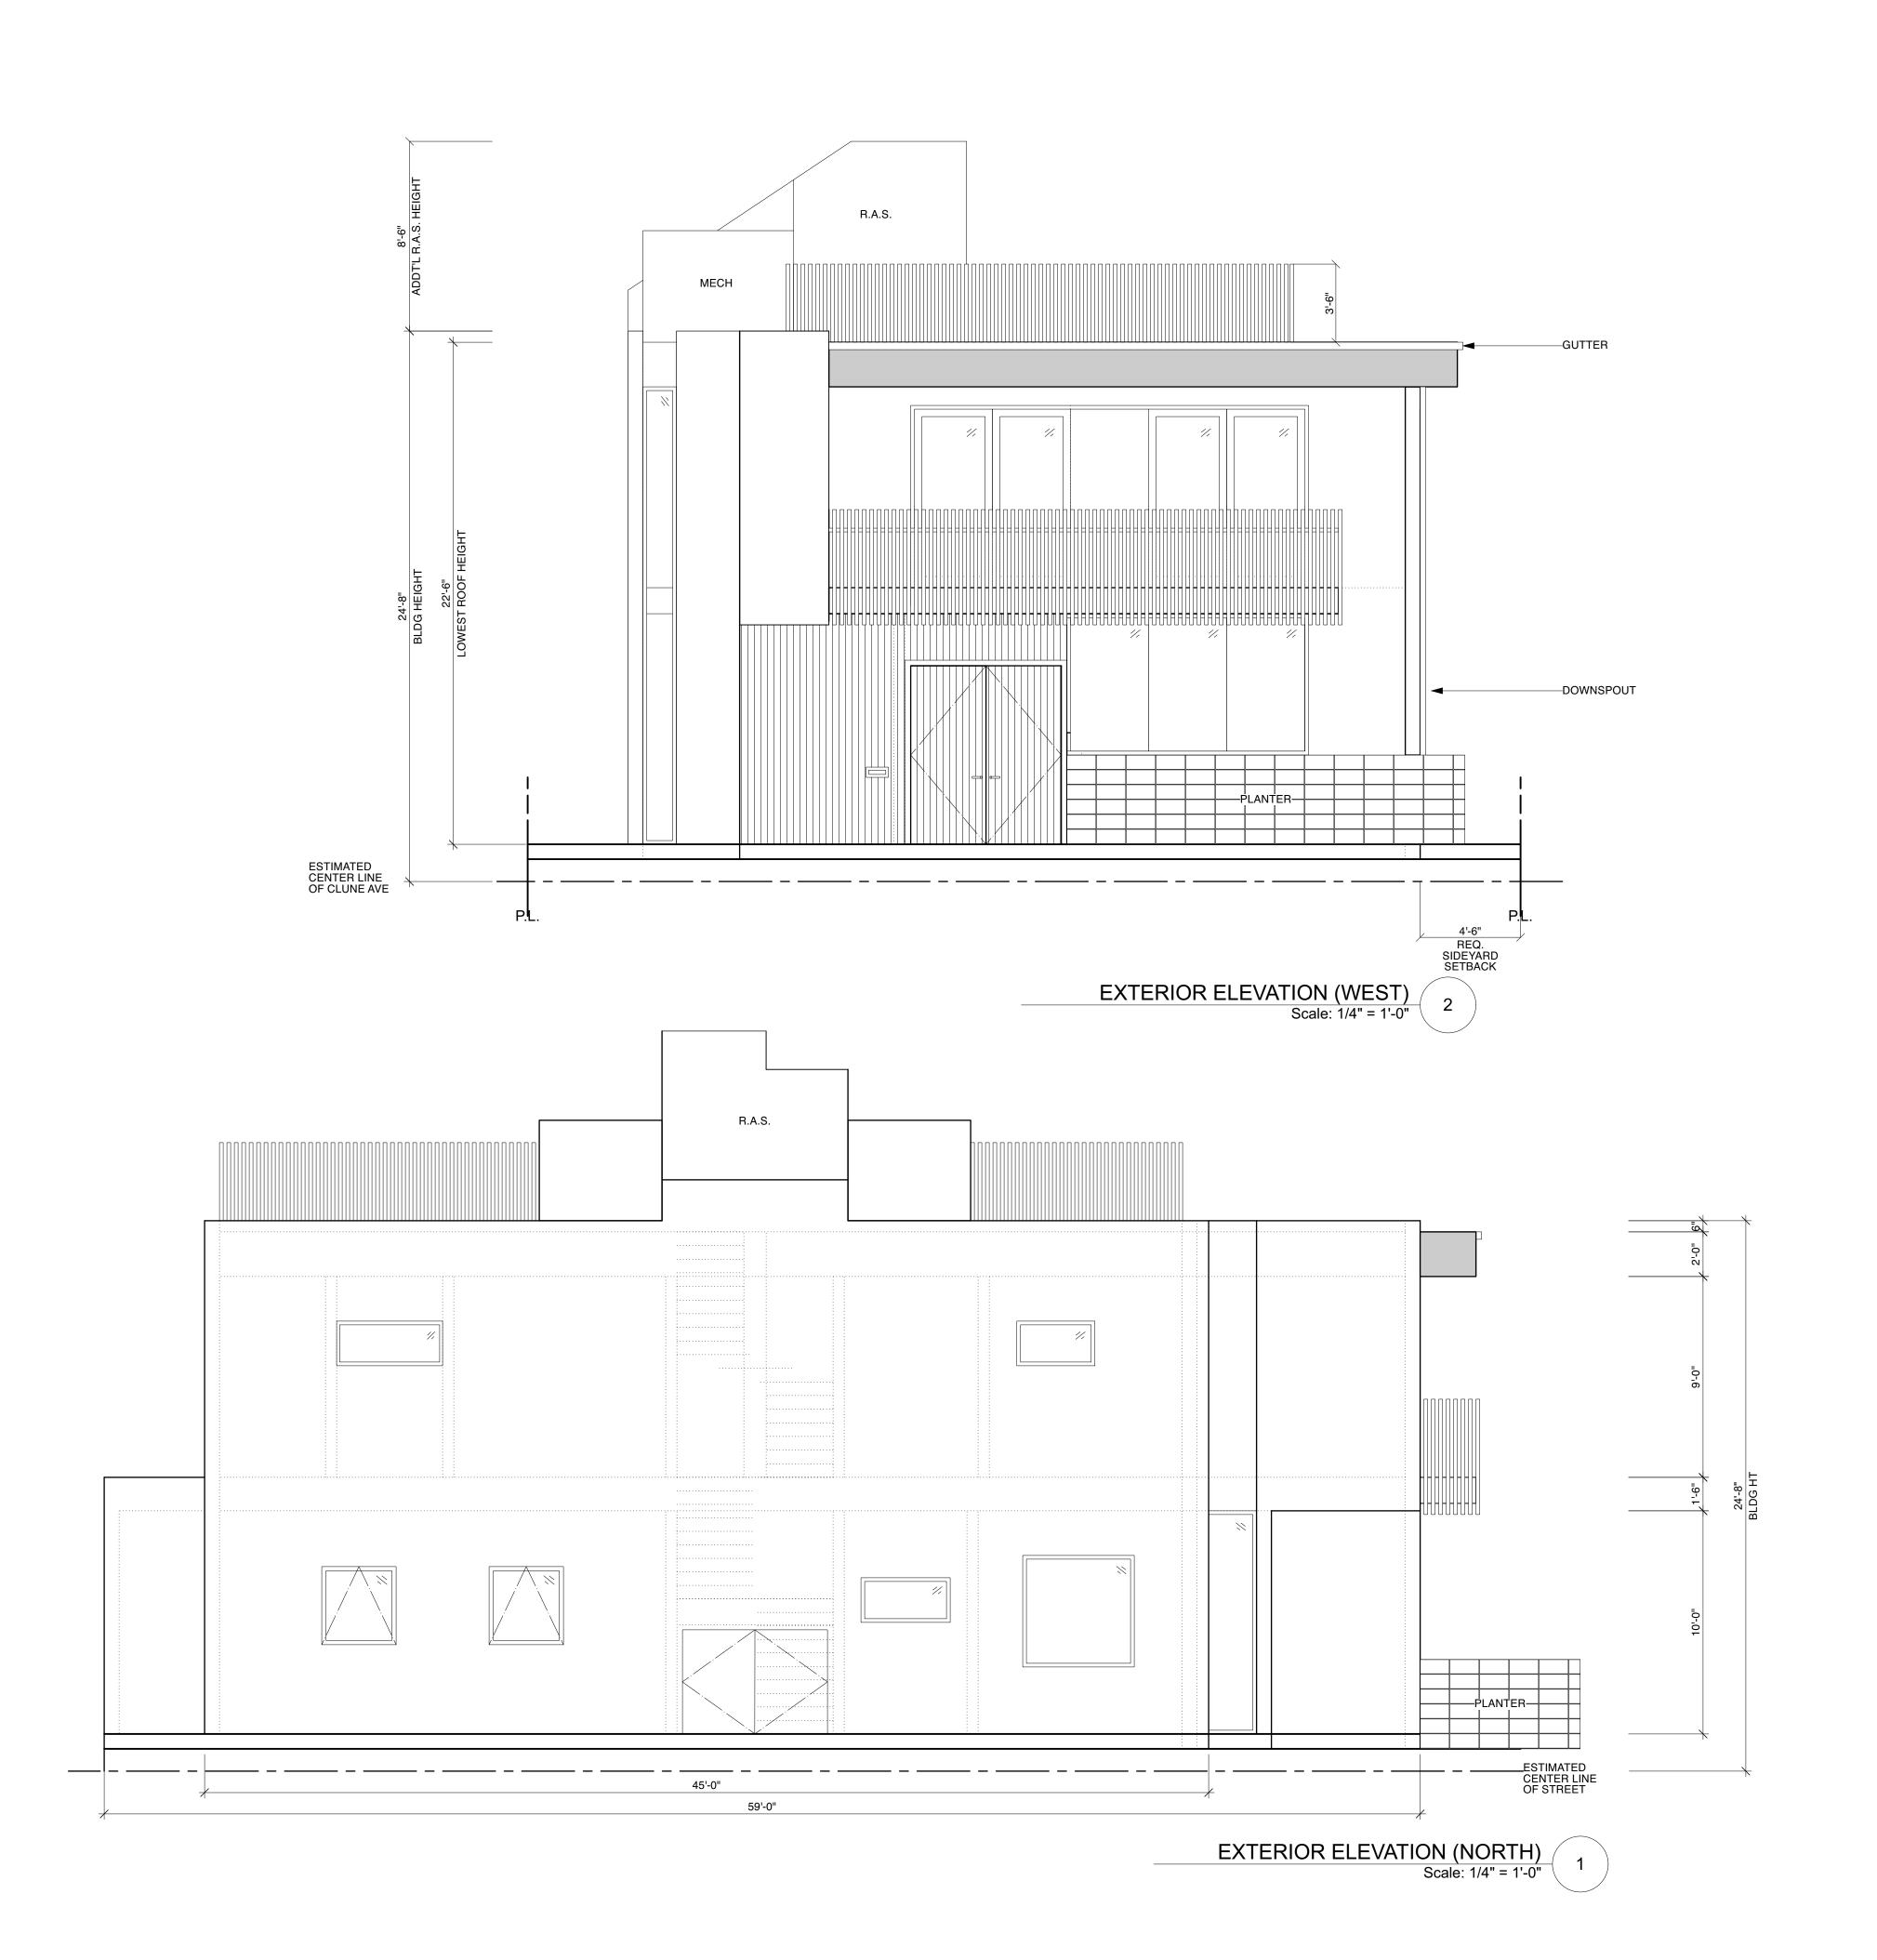

ARCHITECT:



DesignUniversal

ARCHITECTURE AND DESIGN

ROBERT THIBODEAU 812 LINCOLN BLVD. VENICE, CA 90291

PH: 310.452.8161 FX: 310.452.8171

OWNER:

ASAF KOFLER 4500 GRIFFIN AVE. LOS ANGELES, CA 90031

PH: 818.212.0733 EMAIL: ASAF@KOFLERDESIGNBUILD.COM

STRUCTURAL ENGINEER:

SURVEYOR:

**TITLE 24:** 

**CONTRACTOR:** 


REVISION / ISSUE: DATE:

1. PRELIM DESIGN 12.02.2021


EXTERIOR ELEVATIONS

DATE: DRAW 12.02.2021 BMK

A-2.0

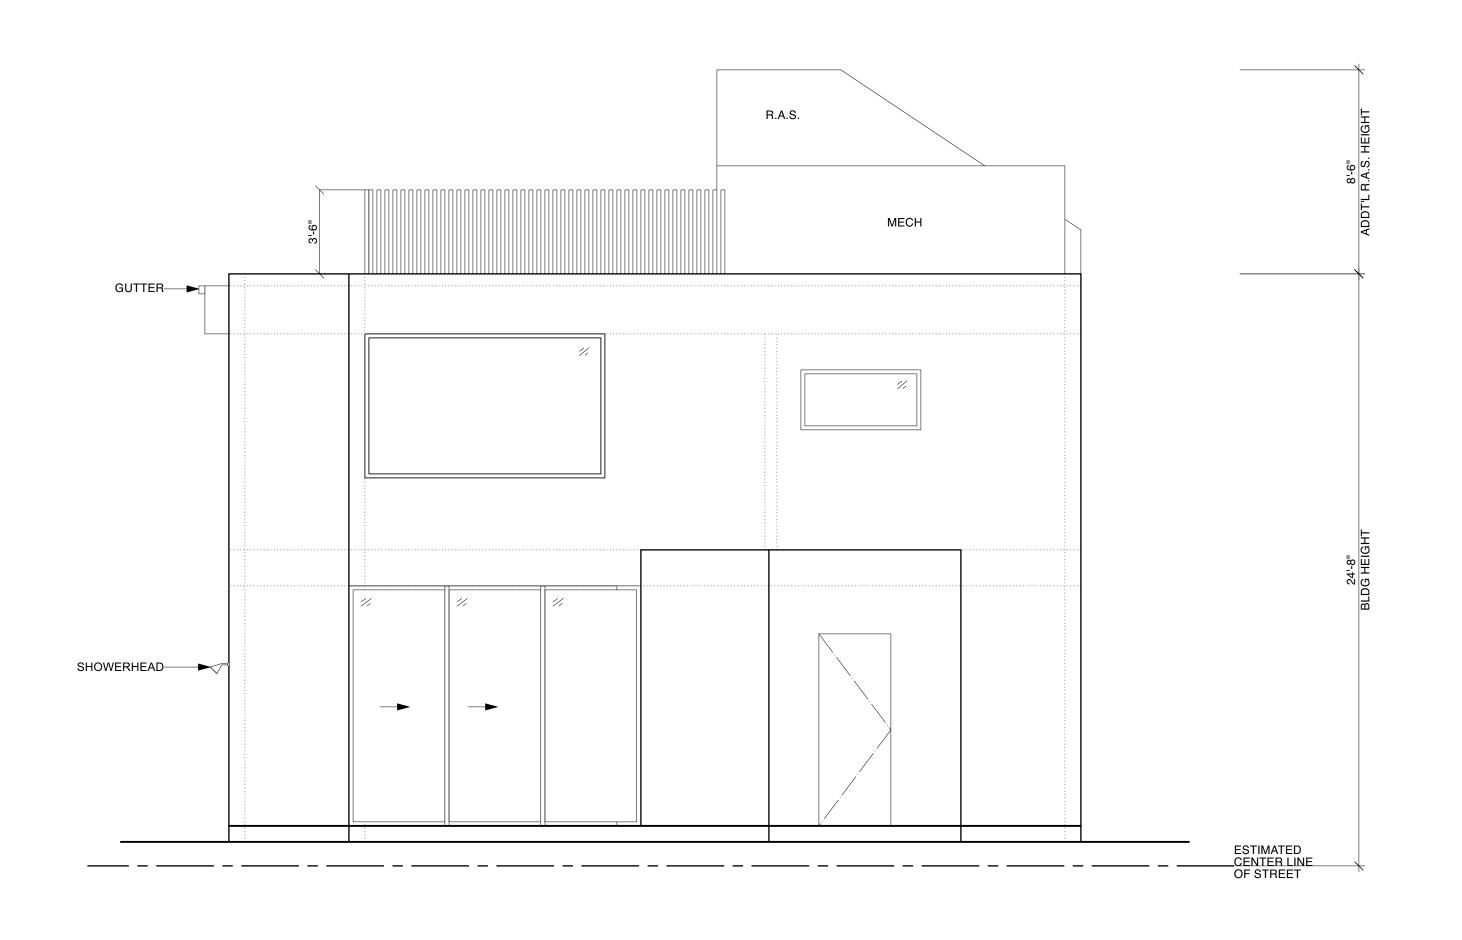



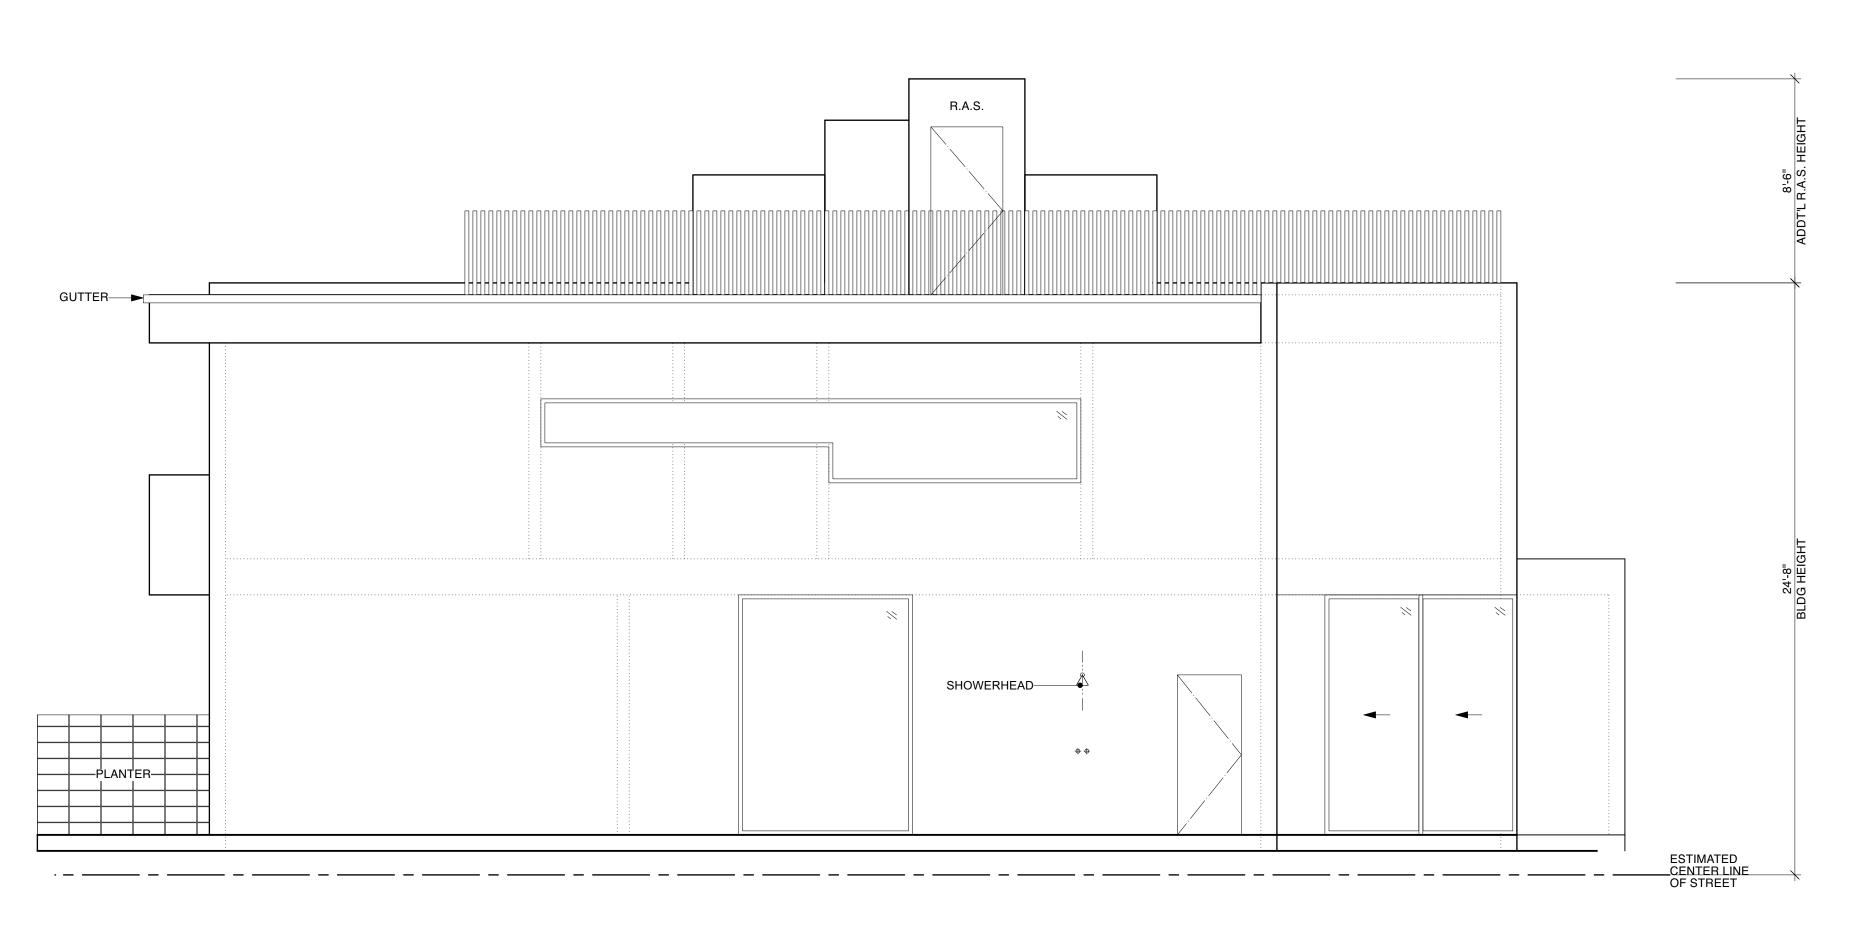

EXTERIOR ELEVATION (SOUTH)

Scale: 1/4" = 1'-0" 1

PROJECT:

2818 S. CLUNE AVE.

VENICE, CA 90291

ARCHITECT:

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<u>TITLE 24:</u>

**CONTRACTOR:** 

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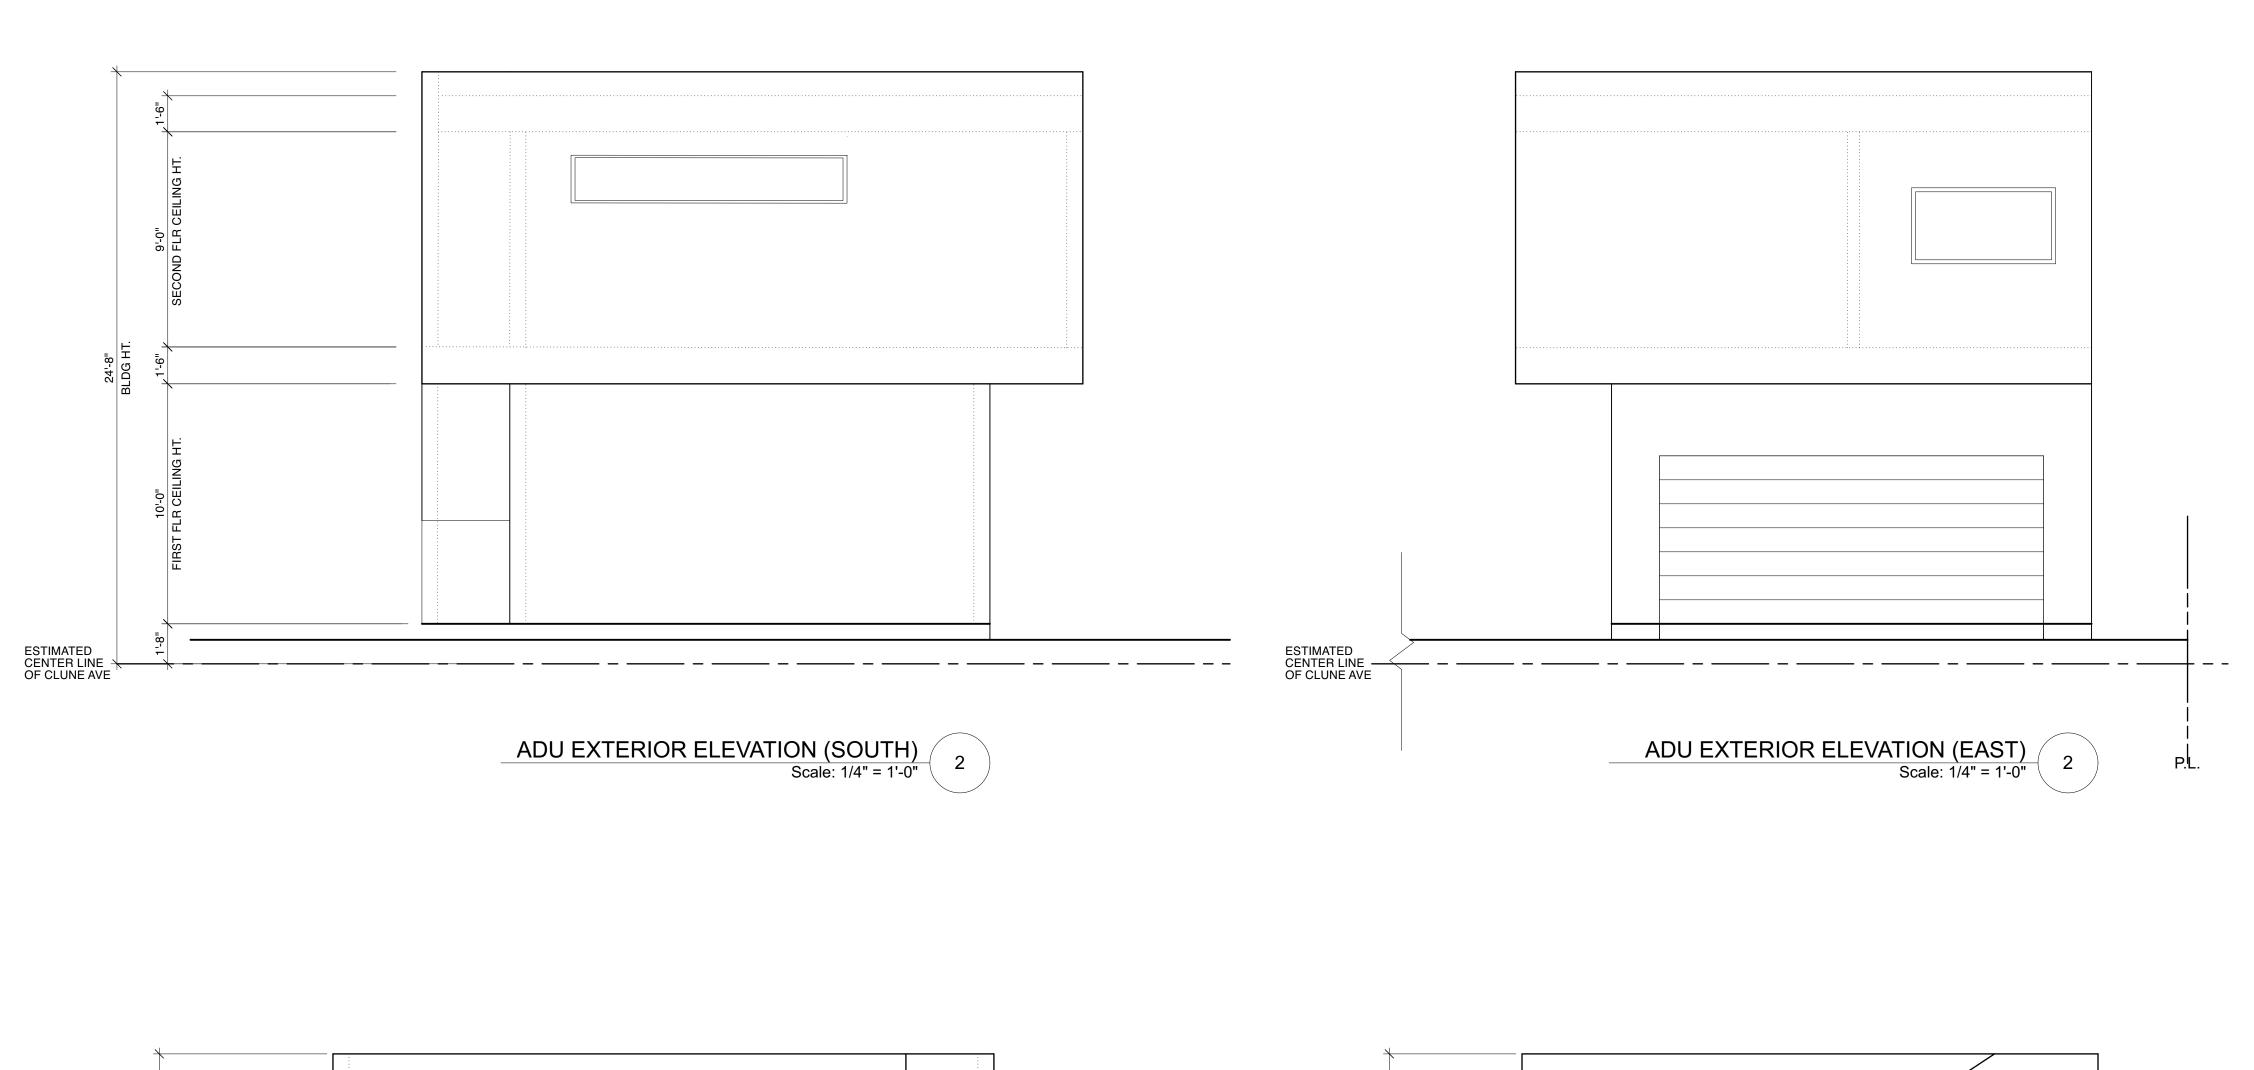
1. PRELIM DESIGN 12.02.2021

EXTERIOR ELEVATIONS

DATE: DRAW 12.02.2021 BMK

SCALE: 1/4" = 1'-0"

A-2.1





ARCHITECT:



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SURVEYOR:

<u>TITLE 24:</u>

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EXTERIOR ELEVATIONS

DATE: DRAWN: S 12.02.2021 BMK 1

A-2.2



WALL TYPE (SEE A-8.0 FOR DETAIL)

ENERGY STAR EXHAUST FAN W/ ACCESSIBLE HUMIDISTAT (50 CFM MIN) TERMINATED TO THE OUTSIDE

☑ D.S. DOWNSPOUT

LEGEND

(N) WALLS 1-HR RATED FIRE WALLS

[\_\_\_\_] DEMO WALLS

PROJECT: 2818 S. CLUNE AVE.

DesignUniversal ARCHITECTURE AND DESIGN

ASAF KOFLER 4500 GRIFFIN AVE. LOS ANGELES, CA 90031


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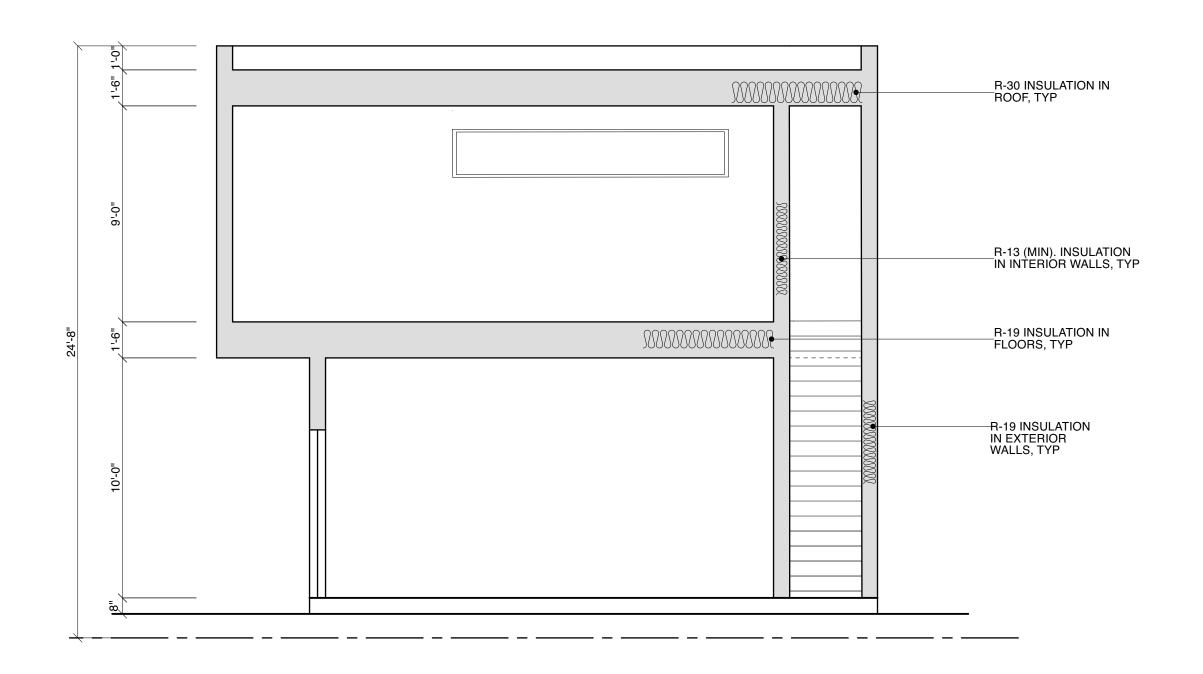
DATE: 12.02.2021


DRAWN: BMK


SCALE:

1/4" = 1'-0"



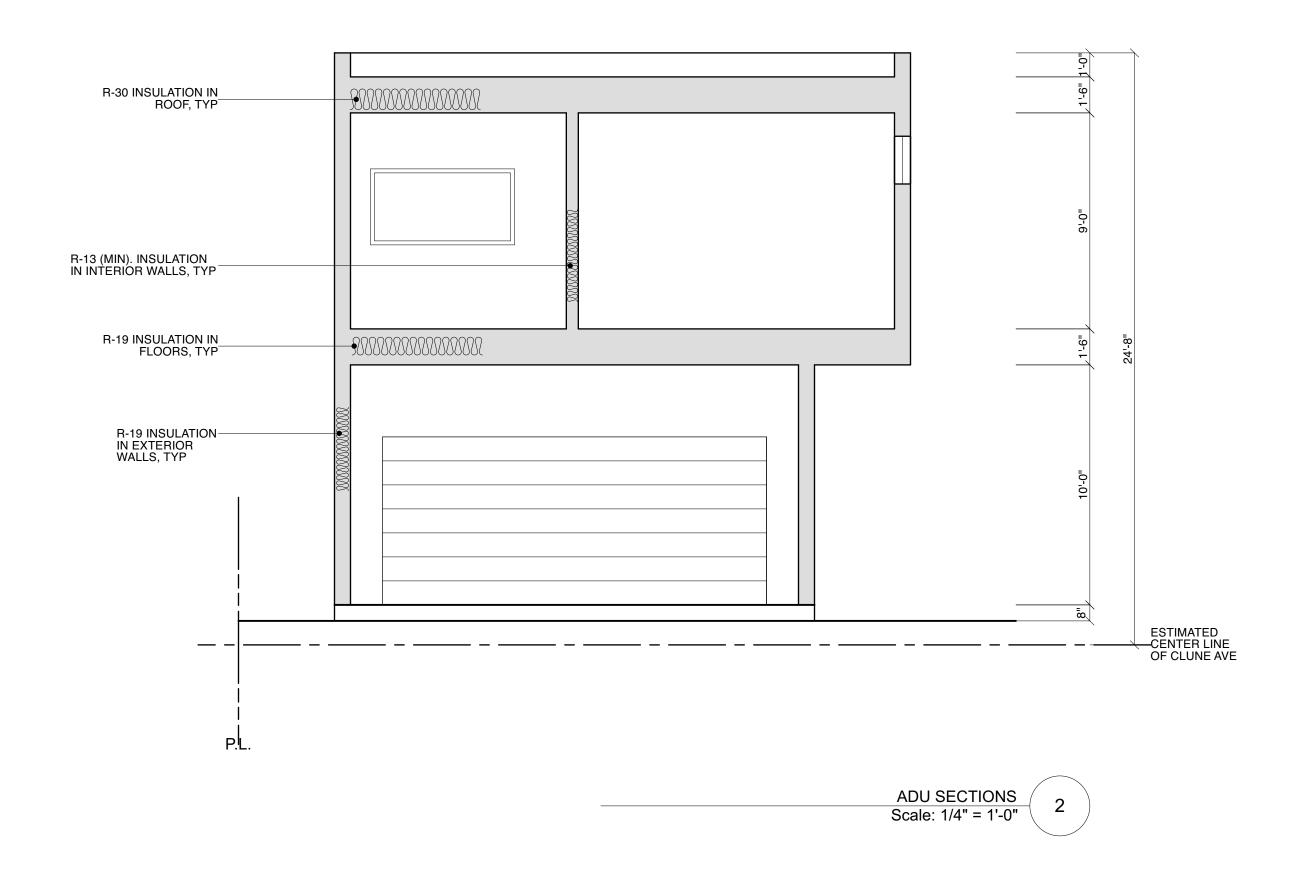

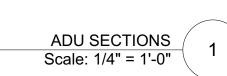

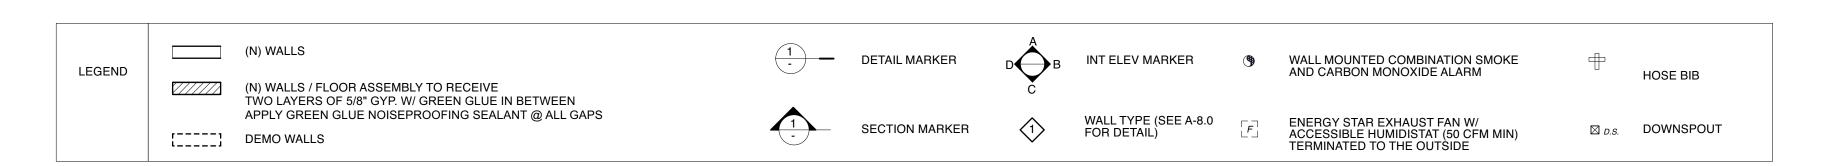

ARCHITECT:



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STRUCTURAL ENGINEER:

SURVEYOR:

<u>TITLE 24:</u>

**CONTRACTOR:** 

REVISION / ISSUE: DATE:

1. PRELIM DESIGN 12.02.2021

SECTIONS

DATE: DRAWN: 12.02.2021 BMK

A-3.1

SCALE:

1/4" = 1'-0"