

PROJECT NAME NEUBURGER RESIDENCE 846 E. MILWOOD AVE _VENICE, CA 90291_

PROJECT NUMBER

2030 HYPERION AVE | LOS ANGELES, CA | 90027

STRUCTURAL ENGINEER: CRAIG PHILLIPS ENGINEERING & 2123 VESTAL AVENUE LOS ANGELES, CA 90026

26074 AVENUE HALL, SUITE 12 VALENCIA, CA 91355


GEOTECHNICAL ENGINEER 1545 VICTORY BLVD. 2ND FLOOR GLENDALE, CA 91201

TITLE 24: NEWTON ENERGY 1730 E. HOLLY AVE, SUITE 755 EL SEGUNDO, CA 90245

C-26132 09/30/2021/

SUBMITTAL RECORD

PERMIT SET

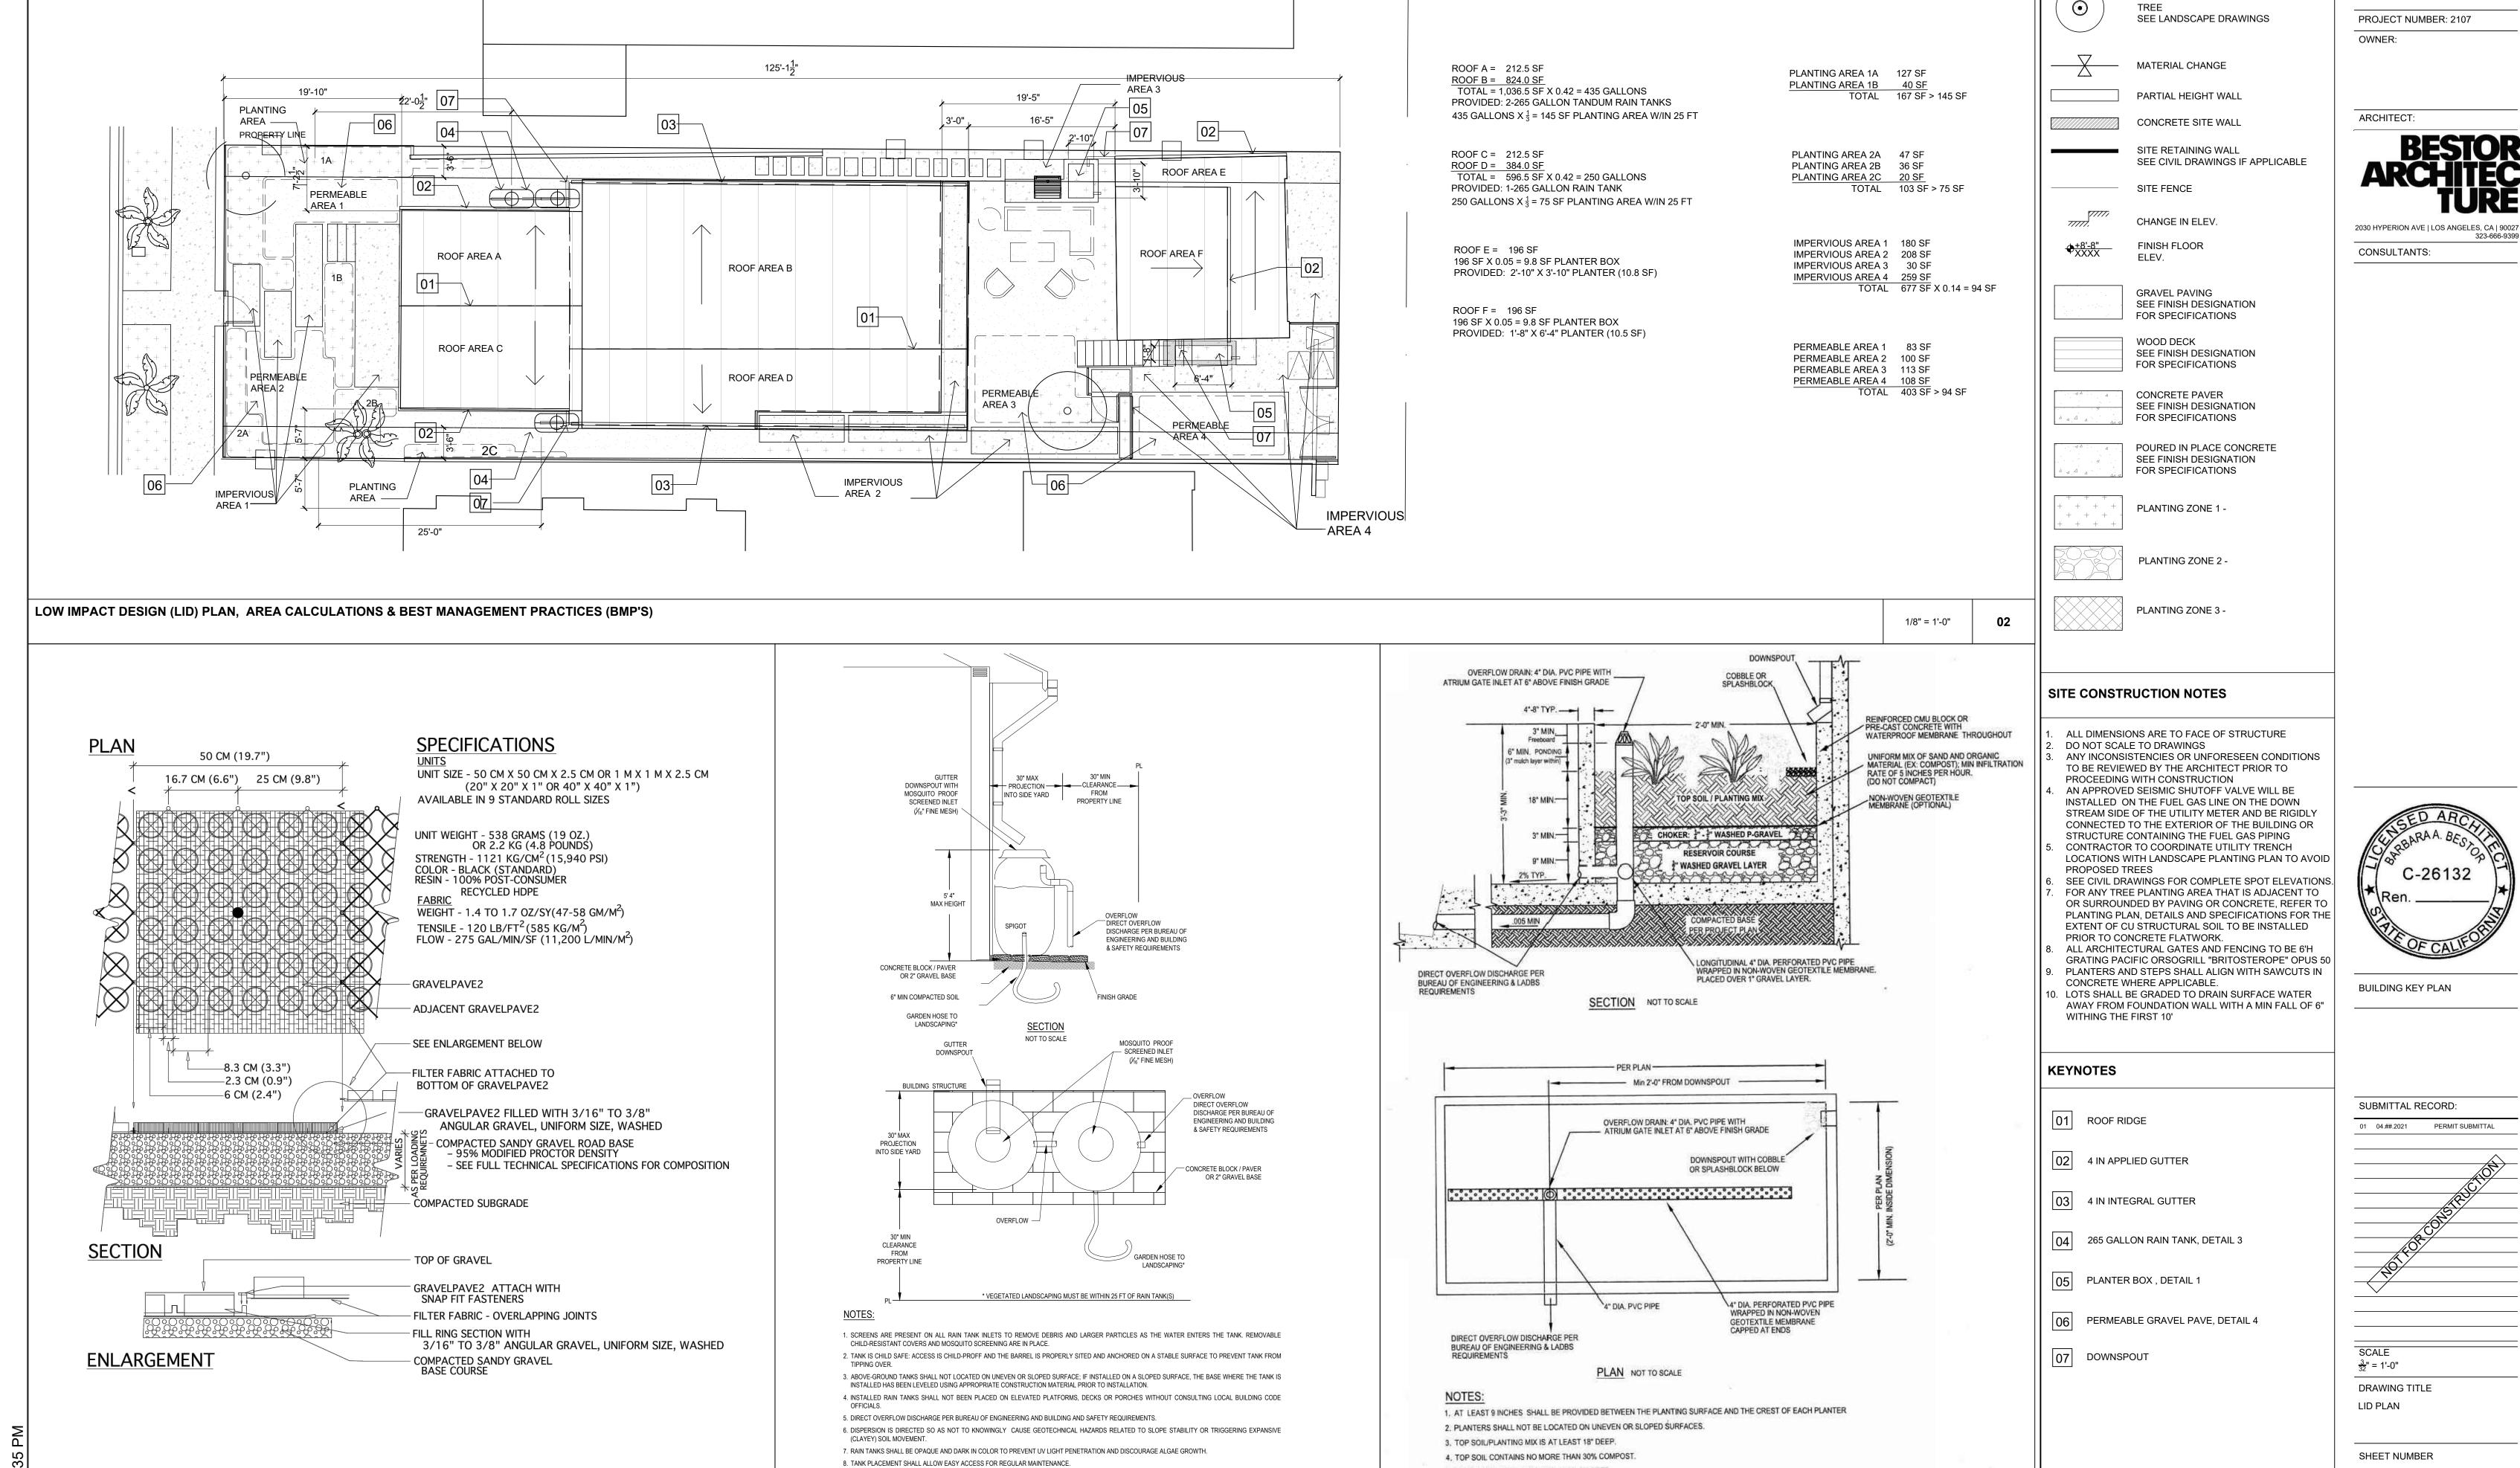

1/8" = 1'-0"

03

COLLAPSIBLE RAIN TANKS ARE NOT PERMITTED.

1/8" = 1'-0"

PERMEABLE GRAVEL PAVE

10. SEE RAIN TANK FACT SHEETS FOR MORE INFORMATION.

MINIMUM GRAVEL LAYER SHALL BE 12" DEEP.

FLOW-THROUGH PLANTER

DIRECT OVERFLOW DISCHARGE PER BUREAU OF ENGINEERING AND BUILDING AND SAFETY REQUIREMENTS.

1/8" = 1'-0"

01

PLANTING IS REQUIRED. CONSULT LANDSCAPE ARCHITECT FOR SPECIFIC PLANT TYPES.

PROJECT NAME & ADDRESS: PROJECT ADDRESS

LEGEND



265 Gallon

Slimline Rainwater Harvesting Tank

TOP VIEW

ST	TRAINER	BASKET	
Material		Polypropy	lei
Color		В	la
Dimensi	ons	16"	x.
Mesh		20x20	S.
	COVI	ER	
Material		Polypropyl	lei


Mesh			
	COVE	R	
Material Color			
Diameter.			1
Inlet	4"	Knockouts	(x
		3" Precut	(x




SIDE VIEW

IAIN	
MaterialPolyethy	
OVERFLOW	
MaterialPolypropy	



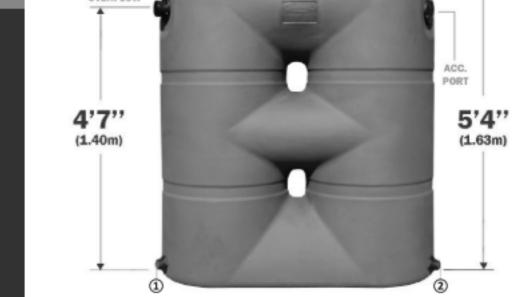

PART NUMBERS

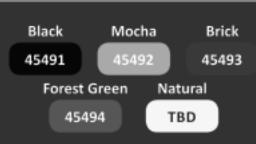










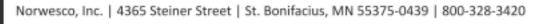

Low Impact Development (LID) Post Construction Stormwater Mitigation Best Management Practices (BMPs)



STORMWATER BMP(s) VERIFICATION

Upon installation of the approved stormwater BMPs, a Stormwater Observation Report (SOR) Form shall be submitted to Department of Public Works, Bureau of Sanitation. 201 N. Figueroa, 3rd floor, station 18. The SOR Form must be with filed and approved by the Bureau of Sanitation prior to the issuance of a Certificate of Occupancy.

Project Address: __846 E. Milwood Avenue, Venice, CA 90291

RESIDENTIAL (4 UNITS OR LESS, <10,000SF, < 2,500 SF within a ESA)

	, , , , , , , , , , , , , , , , , , , ,						
Item #	Stormwater BMP	Description (Units, total)	Reference Sheet(s)* (Sheet #)				
1	Rain Tank(s) - 55 to 130 gal each						
2	Rain Tank(s) - > 130 gal min	3-265 GALLON TANKS	G060				
3	Shade Tree - min 15 gal						
4	Flow thru Planter(s)	2 PLANTERS 21.3 SQ. FT.	G060				
5	Permeable pavers / Porous concrete (min 10% open space)	Incidental; 425 total SF Infiltration; total SF	G060				
6	Rain Garden	# Lined; total SF					
7	Dry Well						
8	SUMP Pump (modification was not required)						

ALL OTHER DEVELOPMENT

 \c (Residential: $5 \ge$ units, $10,000 \ge$ SF, within a ESA and $\ge 2,500$ SF)

/	Item#	Stormwater BMP	Description (Units, total)	Reference Sheet(s)* (Sheet #)
ın	_/	Infiltration Basin / Trench		
Infiltration	2	Dry Wet		
Jul	3	Permeable pavers Porous concrete (min 10% open space)	☐ Incidental;	
oture Use	4	Rain Tank(s) - 530 gal min		
Capture & Use	5	Cistern	☐ Above Grade ☐ Below Grade	
şe	6	Flow thru Planter(s)		
Treat & Discharge	7	Biofiltration	# Lined; total SF	
8.1	8	Vegetative Swale / Filter Strip		
at	9	Catch Basin Filter(s)		
Ę.	10	Trench Drain Filter(s)		
-	11	Down Spout Filter(s)		
	12	SUMP Pump (modification was not required)		

^{*} At a minimum: Site Plan, Architectural Elevations, Roof Plan, Civil Sheets and Detail

PROJECT NUMBER 2107

PROJECT NAME

VENICE, CA 90291

Nikki Neuburger

OWNER

NEUBURGER RESIDENCE 846 E. MILWOOD AVE

ARCHITECT

2030 HYPERION AVE | LOS ANGELES, CA | 90027 323-666-9399

CONSULTANTS

STRUCTURAL ENGINEER: CRAIG PHILLIPS ENGINEERING & DESIGN

2123 VESTAL AVENUE LOS ANGELES, CA 90026 310.625.2325 26074 AVENUE HALL, SUITE 12 VALENCIA, CA 91355 818.891.9100

GEOTECHNICAL ENGINEER: GEOSYSTEMS 1545 VICTORY BLVD. 2ND FLOOR GLENDALE, CA 91201 818.500.9533

TITLE 24: NEWTON ENERGY 1730 E. HOLLY AVE, SUITE 755 EL SEGUNDO, CA 90245 310.375.2699



KEY PLAN

SUBMITTAL RECORD


PERMIT SET

1 06.01.2021

3" = 1'-0" DRAWING TITLE

LID NOTES

Architectural Survey

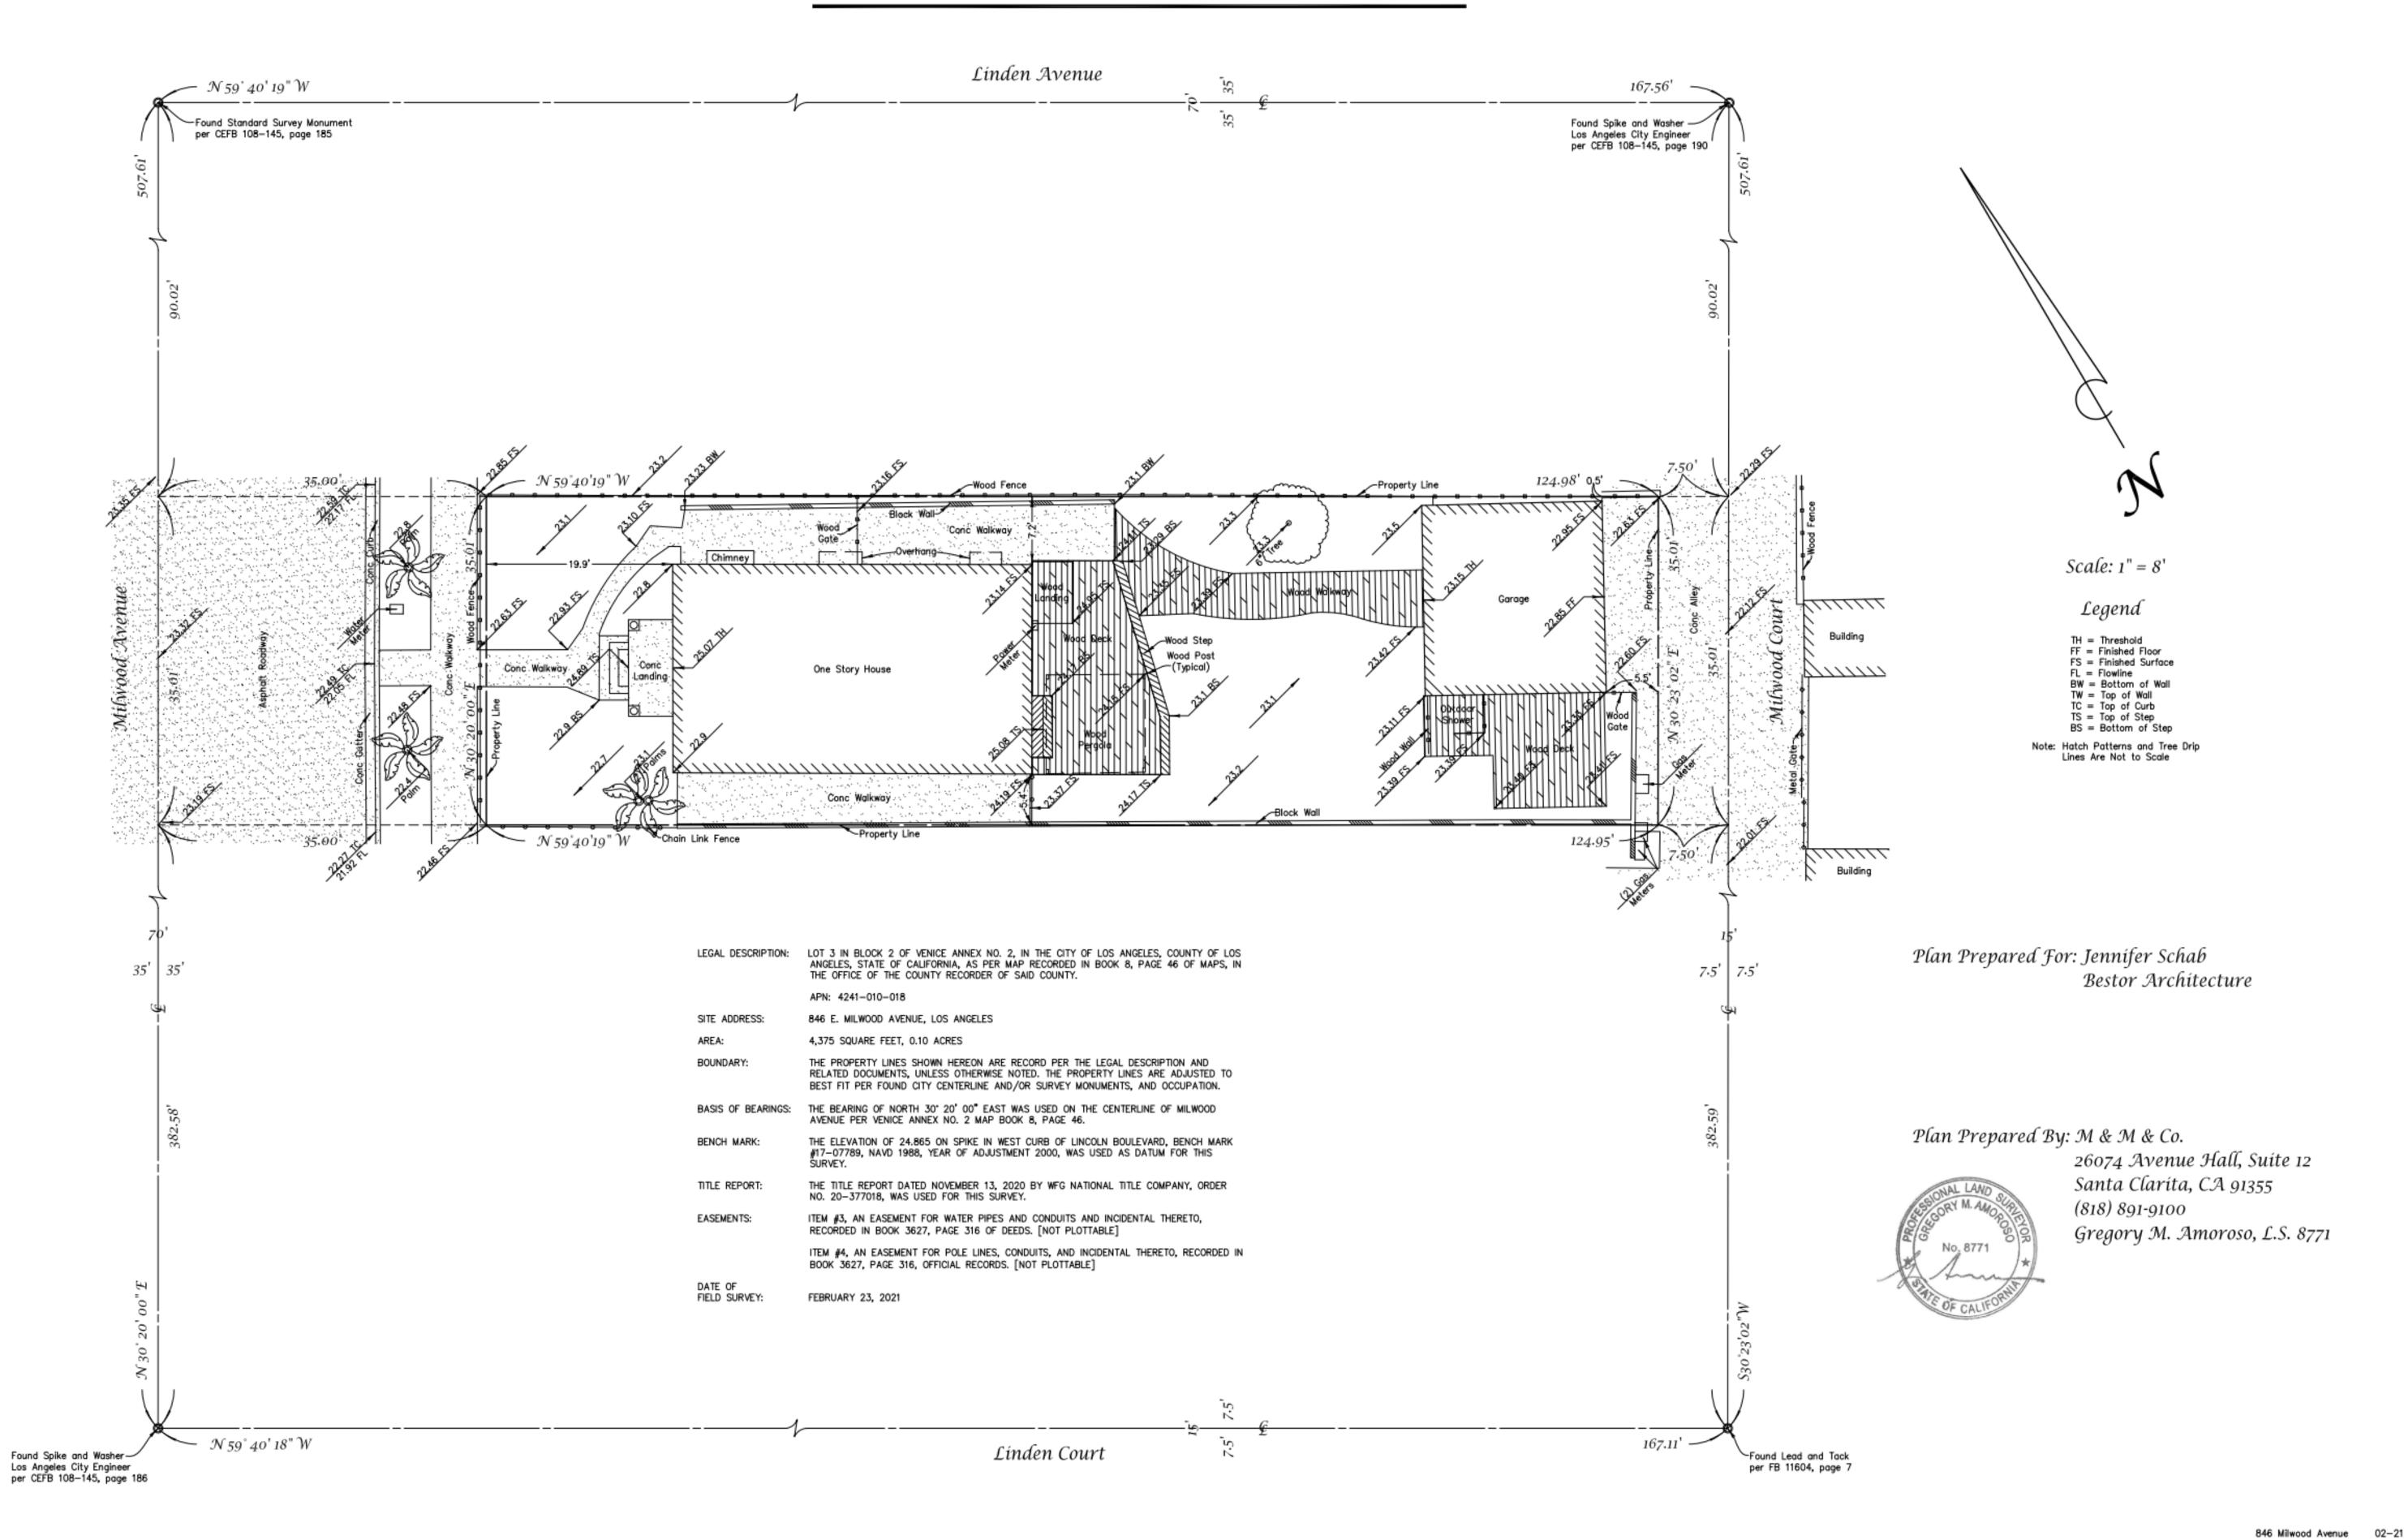

PROJECT NAME

NEUBURGER RESIDENCE

846 E. MILWOOD AVE

_VENICE, CA 90291______

Nikki Neuburger

PROJECT NUMBER

ARCHITECT

BESTOR ARCHITECTURE

CONSULTANTS

STRUCTURAL ENGINEER:
CRAIG PHILLIPS ENGINEERING &
DESIGN
2123 VESTAL AVENUE


310.625.2325 SURVEYOR:

LOS ANGELES, CA 90026

26074 AVENUE HALL, SUITE 12 VALENCIA, CA 91355 818.891.9100

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KEY PLAN

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1 06.01.2021 PERM
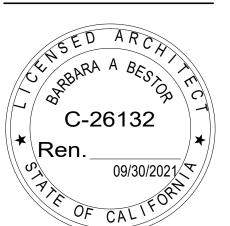
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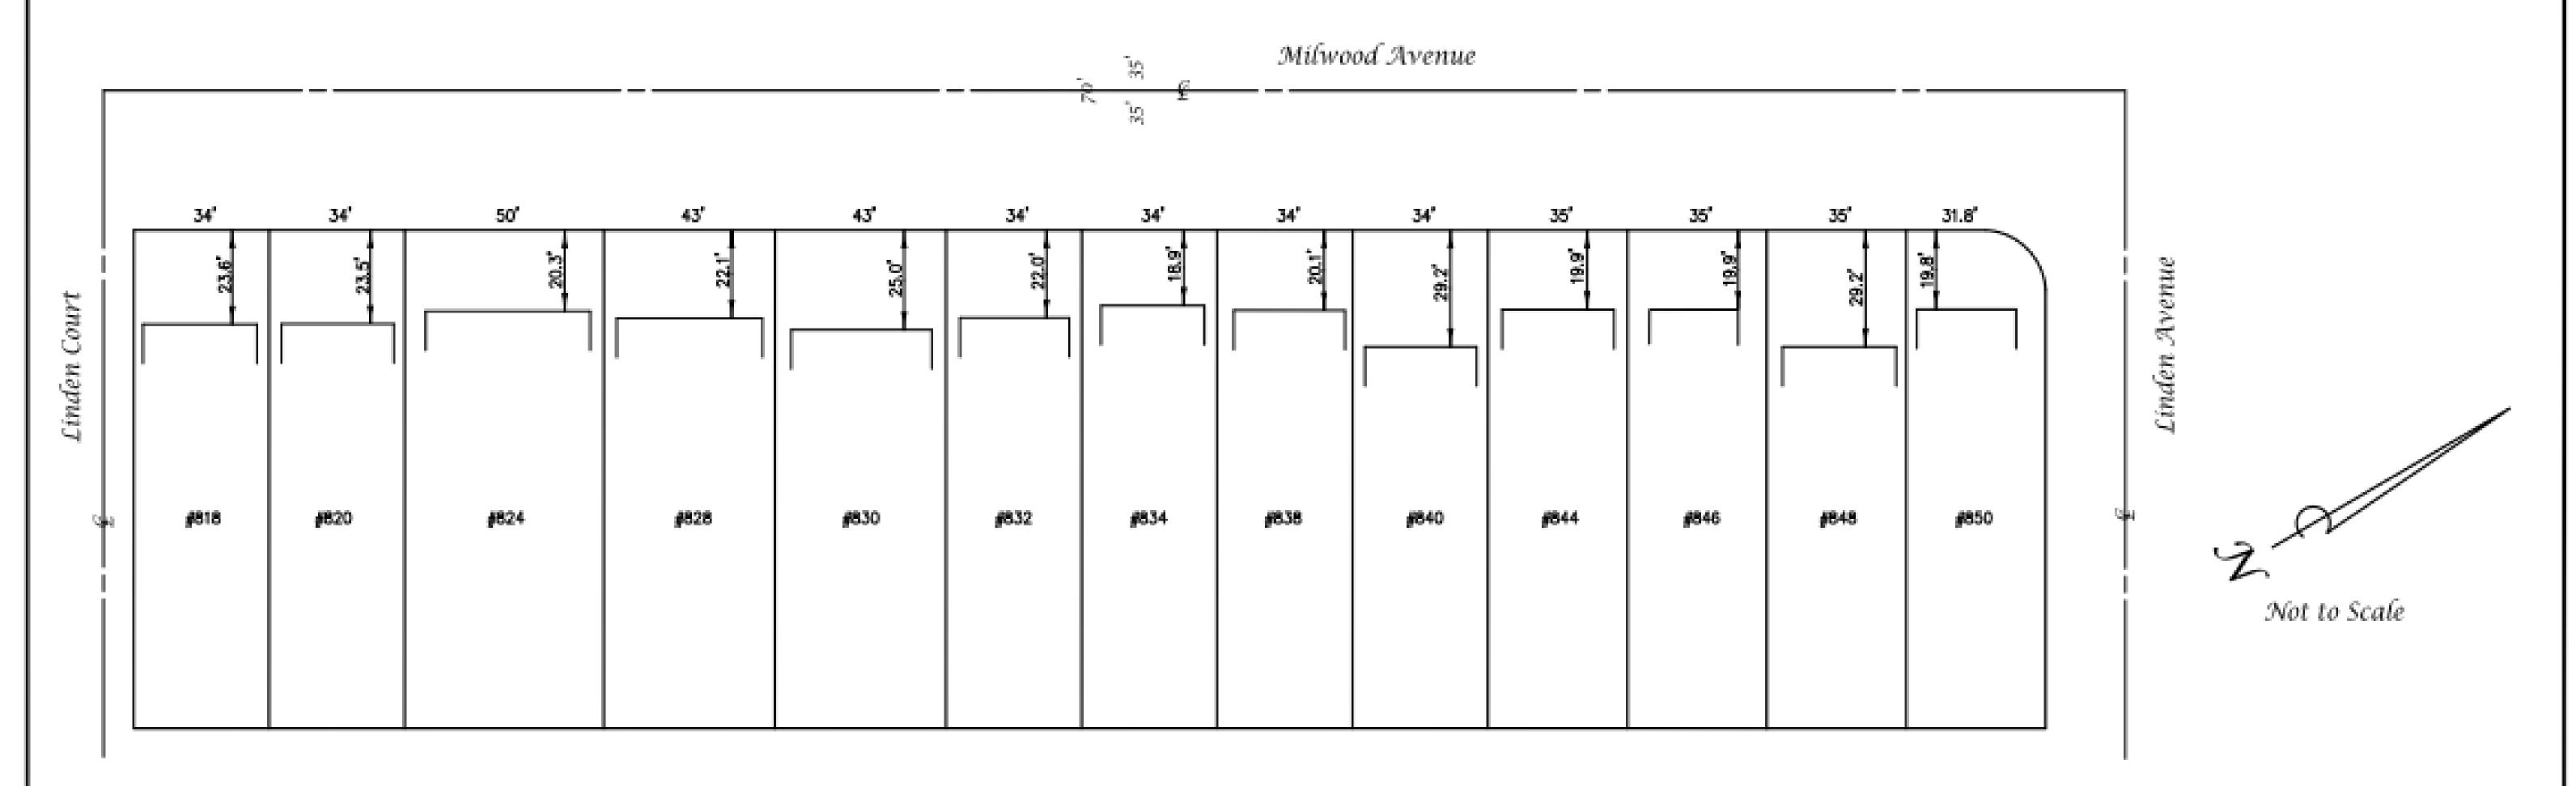
SURVEY

DRAWING TITLE

SHEET NUMBER

S-1

Setback Plan



	Pr ₁	evailing Sett	oack Calc Sheet
	per	City Of Los Angeles, De	partment of Building and Safety
Lot 818 820 824 828 830 832 834 838 840 844 846 846 848	Frontage 34 34 50 43 43 34 34 34 35 35 35 35	Setback 23.6 23.5 20.3 22.1 25.0 22.0 18.9 20.1 29.2 19.9 19.9 19.9	Total number of lots entered = 13 Total frontage entered = 476.8' 40% of Total frontage = 190.72' Number of lots used in the calculations = 11 Setback range used = 18.9'-25.0' Total frontage used in the calculations = 407.8' Lots Used: 818, 820, 824, 828, 830, 832, 834, 838, 844, 846, 850
	F	Prevailing Se	etback = 21.37'

Plan Prepared For: Jennifer Schab Bestor Architecture



Plan Prepared By: M & M & Co. 26074 Avenue Hall, Suite 12 Santa Claríta, CA 91355 (818) 891-9100

Gregory M. Amoroso, L.S. 8771

846 Milwood Avenue

GEOTECHNICAL ENGINEER:
GEOSYSTEMS
1545 VICTORY BLVD. 2ND FLOOR
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26074 AVENUE HALL, SUITE 12

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PROJECT NAME

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PROJECT NUMBER

ARCHITECT

CONSULTANTS

310.625.2325

818.891.9100

2123 VESTAL AVENUE LOS ANGELES, CA 90026

VALENCIA, CA 91355

STRUCTURAL ENGINEER: CRAIG PHILLIPS ENGINEERING &

Nikki Neuburger


OWNER

NEUBURGER RESIDENCE 846 E. MILWOOD AVE



SUBMITTAL RECORD

PREVAILING SETBACK PLA

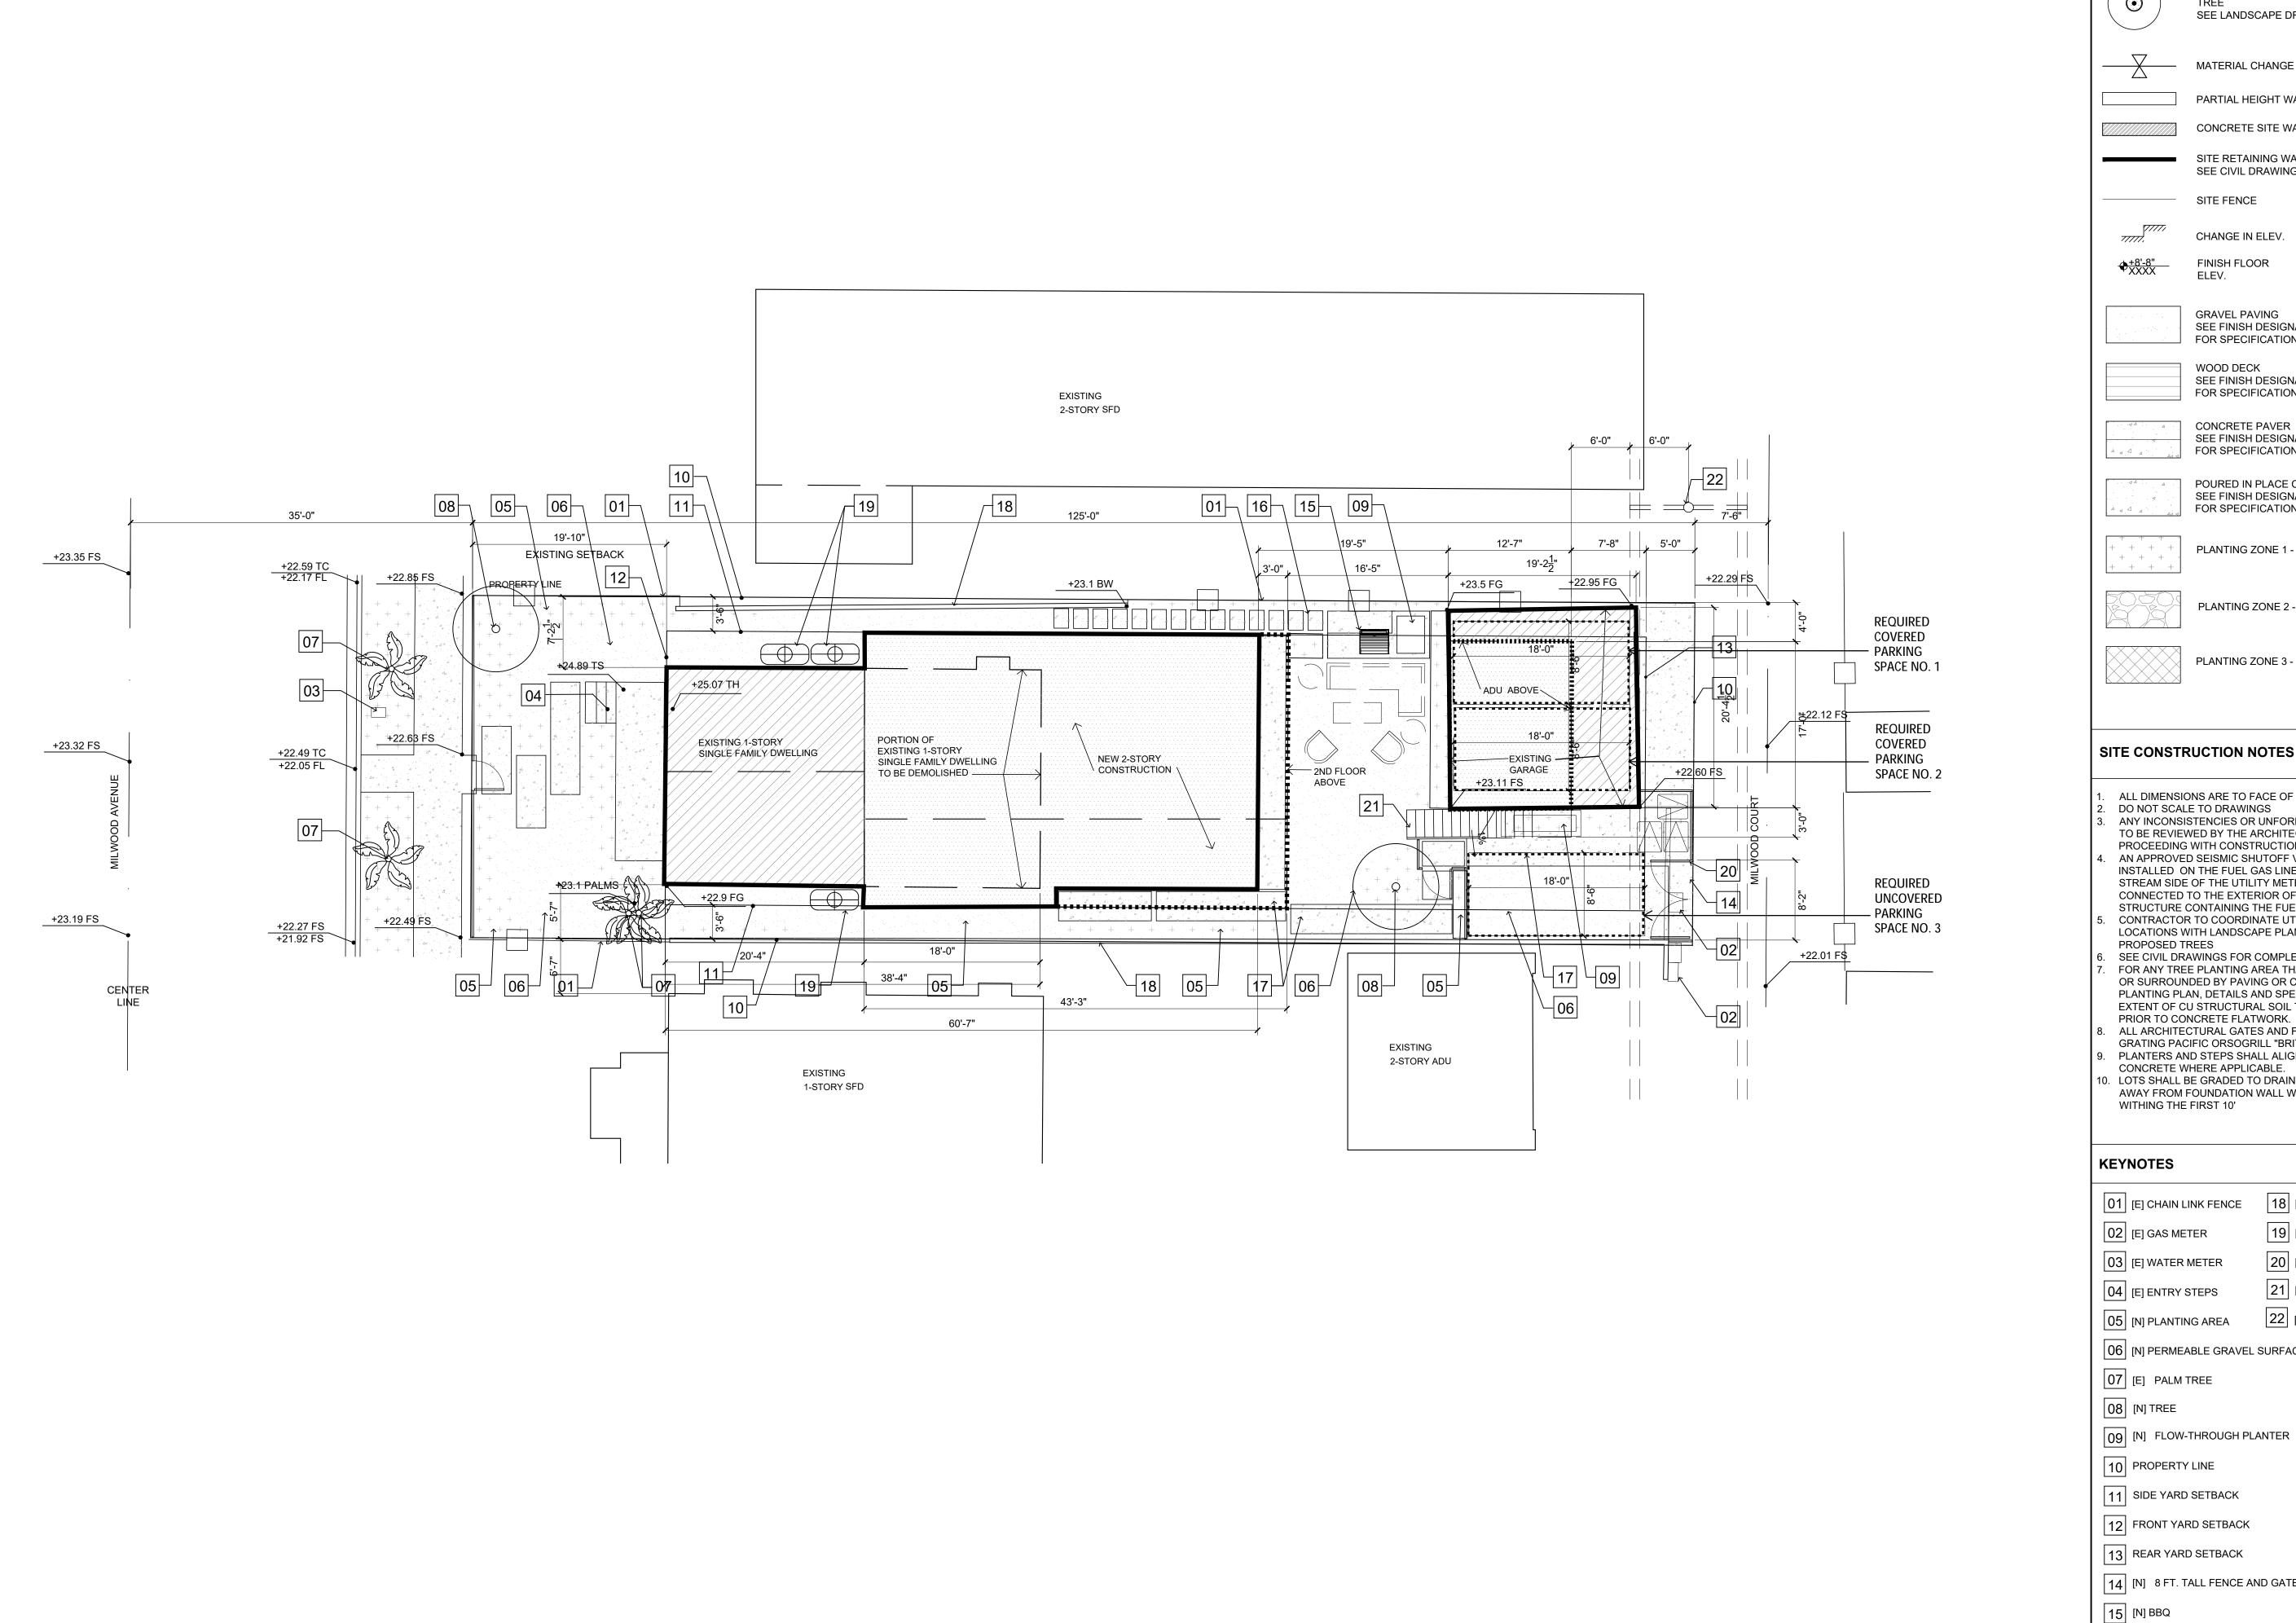

SITE PLAN

PROJECT NAME & ADDRESS: LEGEND PROJECT ADDRESS PROJECT NUMBER: 2107 SEE LANDSCAPE DRAWINGS OWNER: MATERIAL CHANGE PARTIAL HEIGHT WALL ARCHITECT: CONCRETE SITE WALL SITE RETAINING WALL SEE CIVIL DRAWINGS IF APPLICABLE SITE FENCE CHANGE IN ELEV. 2030 HYPERION AVE | LOS ANGELES, CA | 90027 FINISH FLOOR CONSULTANTS: **GRAVEL PAVING** SEE FINISH DESIGNATION FOR SPECIFICATIONS WOOD DECK SEE FINISH DESIGNATION FOR SPECIFICATIONS CONCRETE PAVER SEE FINISH DESIGNATION FOR SPECIFICATIONS POURED IN PLACE CONCRETE SEE FINISH DESIGNATION FOR SPECIFICATIONS PLANTING ZONE 1 -PLANTING ZONE 2 -



- ALL DIMENSIONS ARE TO FACE OF STRUCTURE DO NOT SCALE TO DRAWINGS ANY INCONSISTENCIES OR UNFORESEEN CONDITIONS TO BE REVIEWED BY THE ARCHITECT PRIOR TO
- PROCEEDING WITH CONSTRUCTION AN APPROVED SEISMIC SHUTOFF VALVE WILL BE INSTALLED ON THE FUEL GAS LINE ON THE DOWN STREAM SIDE OF THE UTILITY METER AND BE RIGIDLY CONNECTED TO THE EXTERIOR OF THE BUILDING OR STRUCTURE CONTAINING THE FUEL GAS PIPING CONTRACTOR TO COORDINATE UTILITY TRENCH LOCATIONS WITH LANDSCAPE PLANTING PLAN TO AVOID
- SEE CIVIL DRAWINGS FOR COMPLETE SPOT ELEVATIONS FOR ANY TREE PLANTING AREA THAT IS ADJACENT TO OR SURROUNDED BY PAVING OR CONCRETE, REFER TO PLANTING PLAN, DETAILS AND SPECIFICATIONS FOR THE EXTENT OF CU STRUCTURAL SOIL TO BE INSTALLED PRIOR TO CONCRETE FLATWORK.
- ALL ARCHITECTURAL GATES AND FENCING TO BE 6'H GRATING PACIFIC ORSOGRILL "BRITOSTEROPE" OPUS 50 PLANTERS AND STEPS SHALL ALIGN WITH SAWCUTS IN
- . LOTS SHALL BE GRADED TO DRAIN SURFACE WATER AWAY FROM FOUNDATION WALL WITH A MIN FALL OF 6"



SUBMITTAL RECORD:

01 04.##.2021 PERMIT SUBMITTAL

18 [E] CMU WALL

[N] RAIN WATER TANK

20 [N] AUTO GATE

21 [N] STAIR TO ADU [E] POWER POLE


06 [N] PERMEABLE GRAVEL SURFACE

14 [N] 8 FT. TALL FENCE AND GATE

1/8" = 1'-0"


16 [N] PRE-FAB CONC. PAVERS

17 [N] POURED IN PLACE CONCRETE

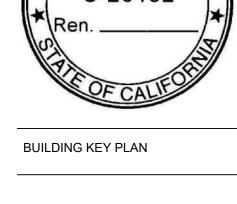

DRAWING TITLE SITE PLAN

1/8" = 1'-0"

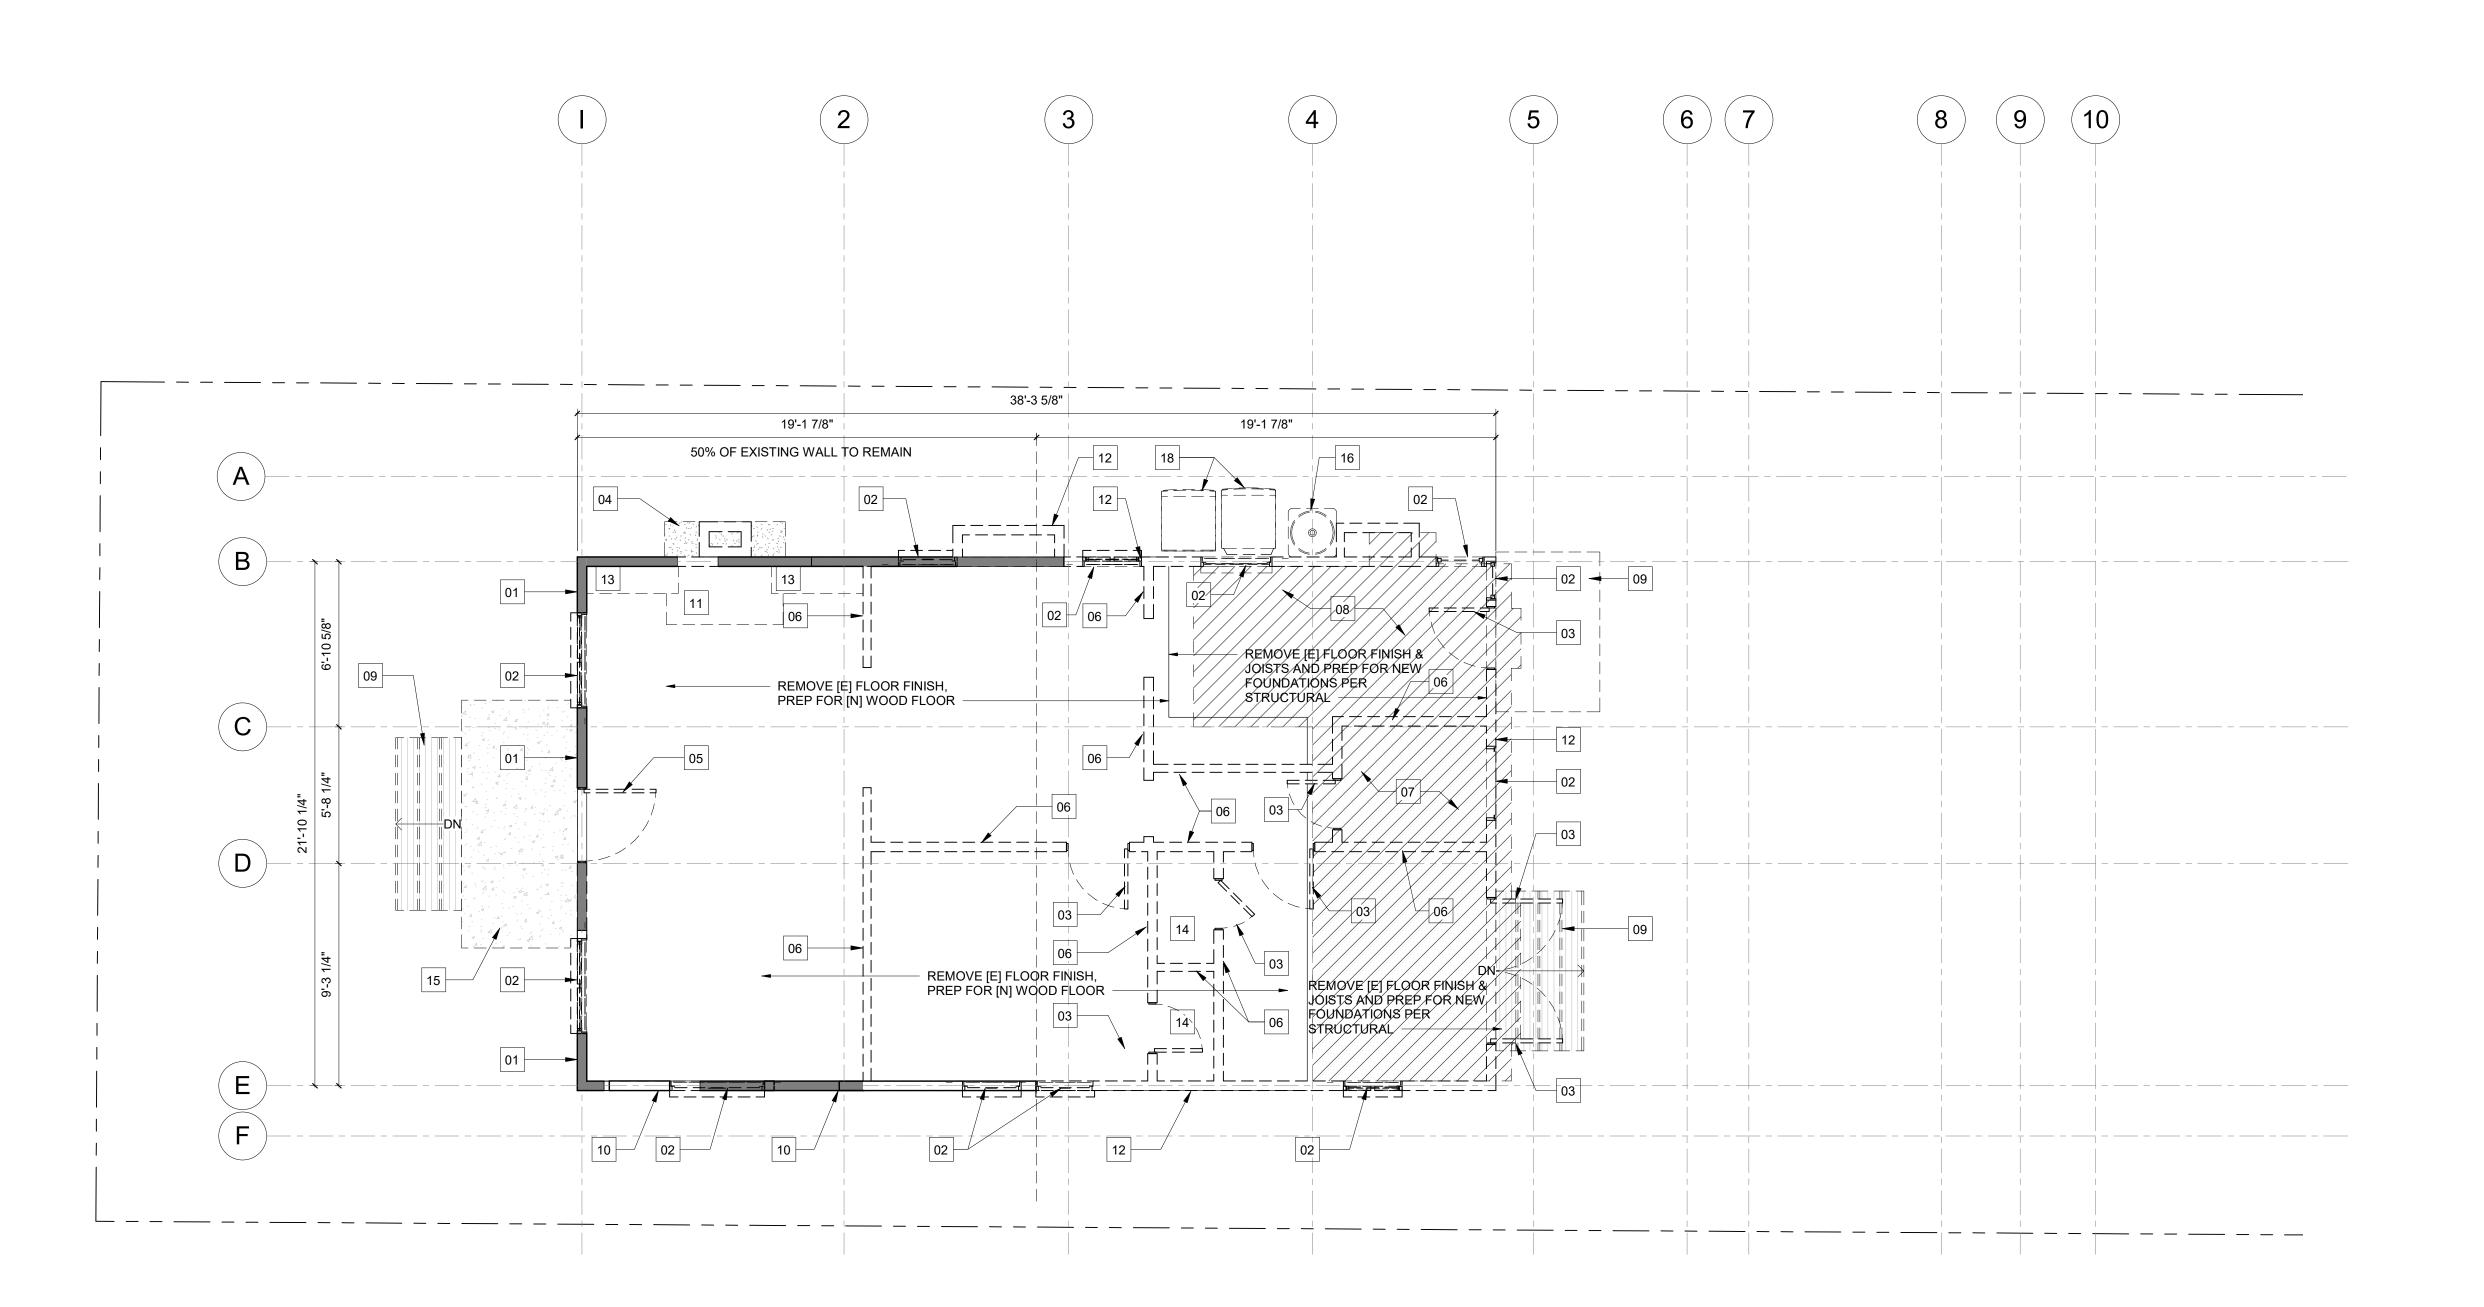

LEGEND

PARTITIONS

EXISTING TO REMAIN

TO BE DEMOLISHED

EXISTING ROOF TO REMAIN

DIMENSIONS — FACE OF FINISH FACE OF FRAMING

CONSTRUCTION NOTES

- EXERCISE CARE AND PROTECT ALL FINISHES AND ELEMENTS TO REMAIN.
- CONTRACTOR SHALL BE RESPONSIBLE FOR PROTECTION & PRESERVATION OF ALL MATERIALS, SUPPLIES & EQUIPMENT OF EVERY DESCRIPTION (INCLUDING PROPERTY WHICH MAY BE FURNISHED OR OWNED BY OWNER OR BY OTHERS), WHILE SUCH PROPERTY IS LOCATED ON THE CONSTRUCTION SITE, & FOR ALL WORK PERFORMED.
- REMOVE & DISPOSE OF ALL ITEMS INDICATED ON THE DRAWINGS. VERIFY DISPOSAL AND SALVAGE WITH CLIENT RESERVES THE RIGHT TO SALVAGE ANY DEMO ITEM. REMOVE, PROTECT, AND TURN OVER SUCH ITEMS
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- CONTRACTOR TO COORDINATE LOCATIONS OF ALL DEMO SLABS & WALL OPENINGS W/ ARCHITECTURAL AND CONSULTANT DRAWINGS.
- 9. (E) COLUMNS TO REMAIN U.N.O.

KEYNOTES - DEMO

[E] WALL TO REMAIN

- EXISTING OPENING TO REMAIN, REMOVE [E] WINDOW
- REMOVE [E] DOOR
- 04 REMOVE [E] FIREPLACE & CHIMNEY
 05 EXISTING OPENING TO REMAIN, REMOVE [E] DOOR 06 REMOVE [E] INTERIOR WALL
- 07 REMOVE [E] PLUMBING FIXTURES AND CABINETS
- 08 REMOVE [E] KITCHEN APPLIANCES, PLUMBING FIXTURES, FINISHES AND CABINETS 09 REMOVE [E] EXTERIOR STEPS AND LANDING
- 10 REMOVE [E] PORTION OF WALL & PREP FOR [N]
- 11 REMOVE [E] HEARTH & PREP FOR [N] FLOORING
- 12 REMOVE [E] EXTERIOR WALL
- 13 REMOVE [E] CABINETRY
- 14 REMOVE [E] SHELF & POLE
- 15 REMOVE [E] FRONT PORCH, POSTS & ROOF 16 REMOVE [E] EXTERIOR AIR CONDITIONER UNIT
- 17 REMOVE [E] ROOF FINISH & PREP FOR [N] ROOF FINISH
- 18 REMOVE [E] WASHER & DRYER
- 19 REMOVE [E] WINDOW 20 REMOVE [E] ROOF

DEMOLITION PLAN CALCULATIONS

EXISTING EXTERIOR WALL LENGTH = 121' - 1"

EXTERIOR WALL LENGTH MAINTAINED = 62' -10" PERCENT OF EXTERIOR WALL MAINTAINED = 51.8%

EXISTING ROOF AREA = 834.5 SF

EXISTING ROOF AREA MAINTAINED = 451.4 SF

PERCENT OF EXISTING ROOF MAINTAINED = 54%

NEUBURGER RESIDENCE 846 E. MILWOOD AVE _VENICE, CA 90291_ OWNER

Nikki Neuburger

PROJECT NAME

PROJECT NUMBER

2107 ARCHITECT



2030 HYPERION AVE | LOS ANGELES, CA | 90027

CONSULTANTS

310.625.2325

818.891.9100

STRUCTURAL ENGINEER: CRAIG PHILLIPS ENGINEERING & DESIGN 2123 VESTAL AVENUE LOS ANGELES, CA 90026

26074 AVENUE HALL, SUITE 12 VALENCIA, CA 91355

GEOTECHNICAL ENGINEER GEOSYSTEMS 1545 VICTORY BLVD. 2ND FLOOR GLENDALE, CA 91201 818.500.9533

TITLE 24: NEWTON ENERGY 1730 E. HOLLY AVE, SUITE 755 EL SEGUNDO, CA 90245 310.375.2699



KEY PLAN


SUBMITTAL RECORD

PERMIT SET 1 06.01.2021

SCALE 1/4" = 1'-0"

DRAWING TITLE

DEMO FLOOR PLAN

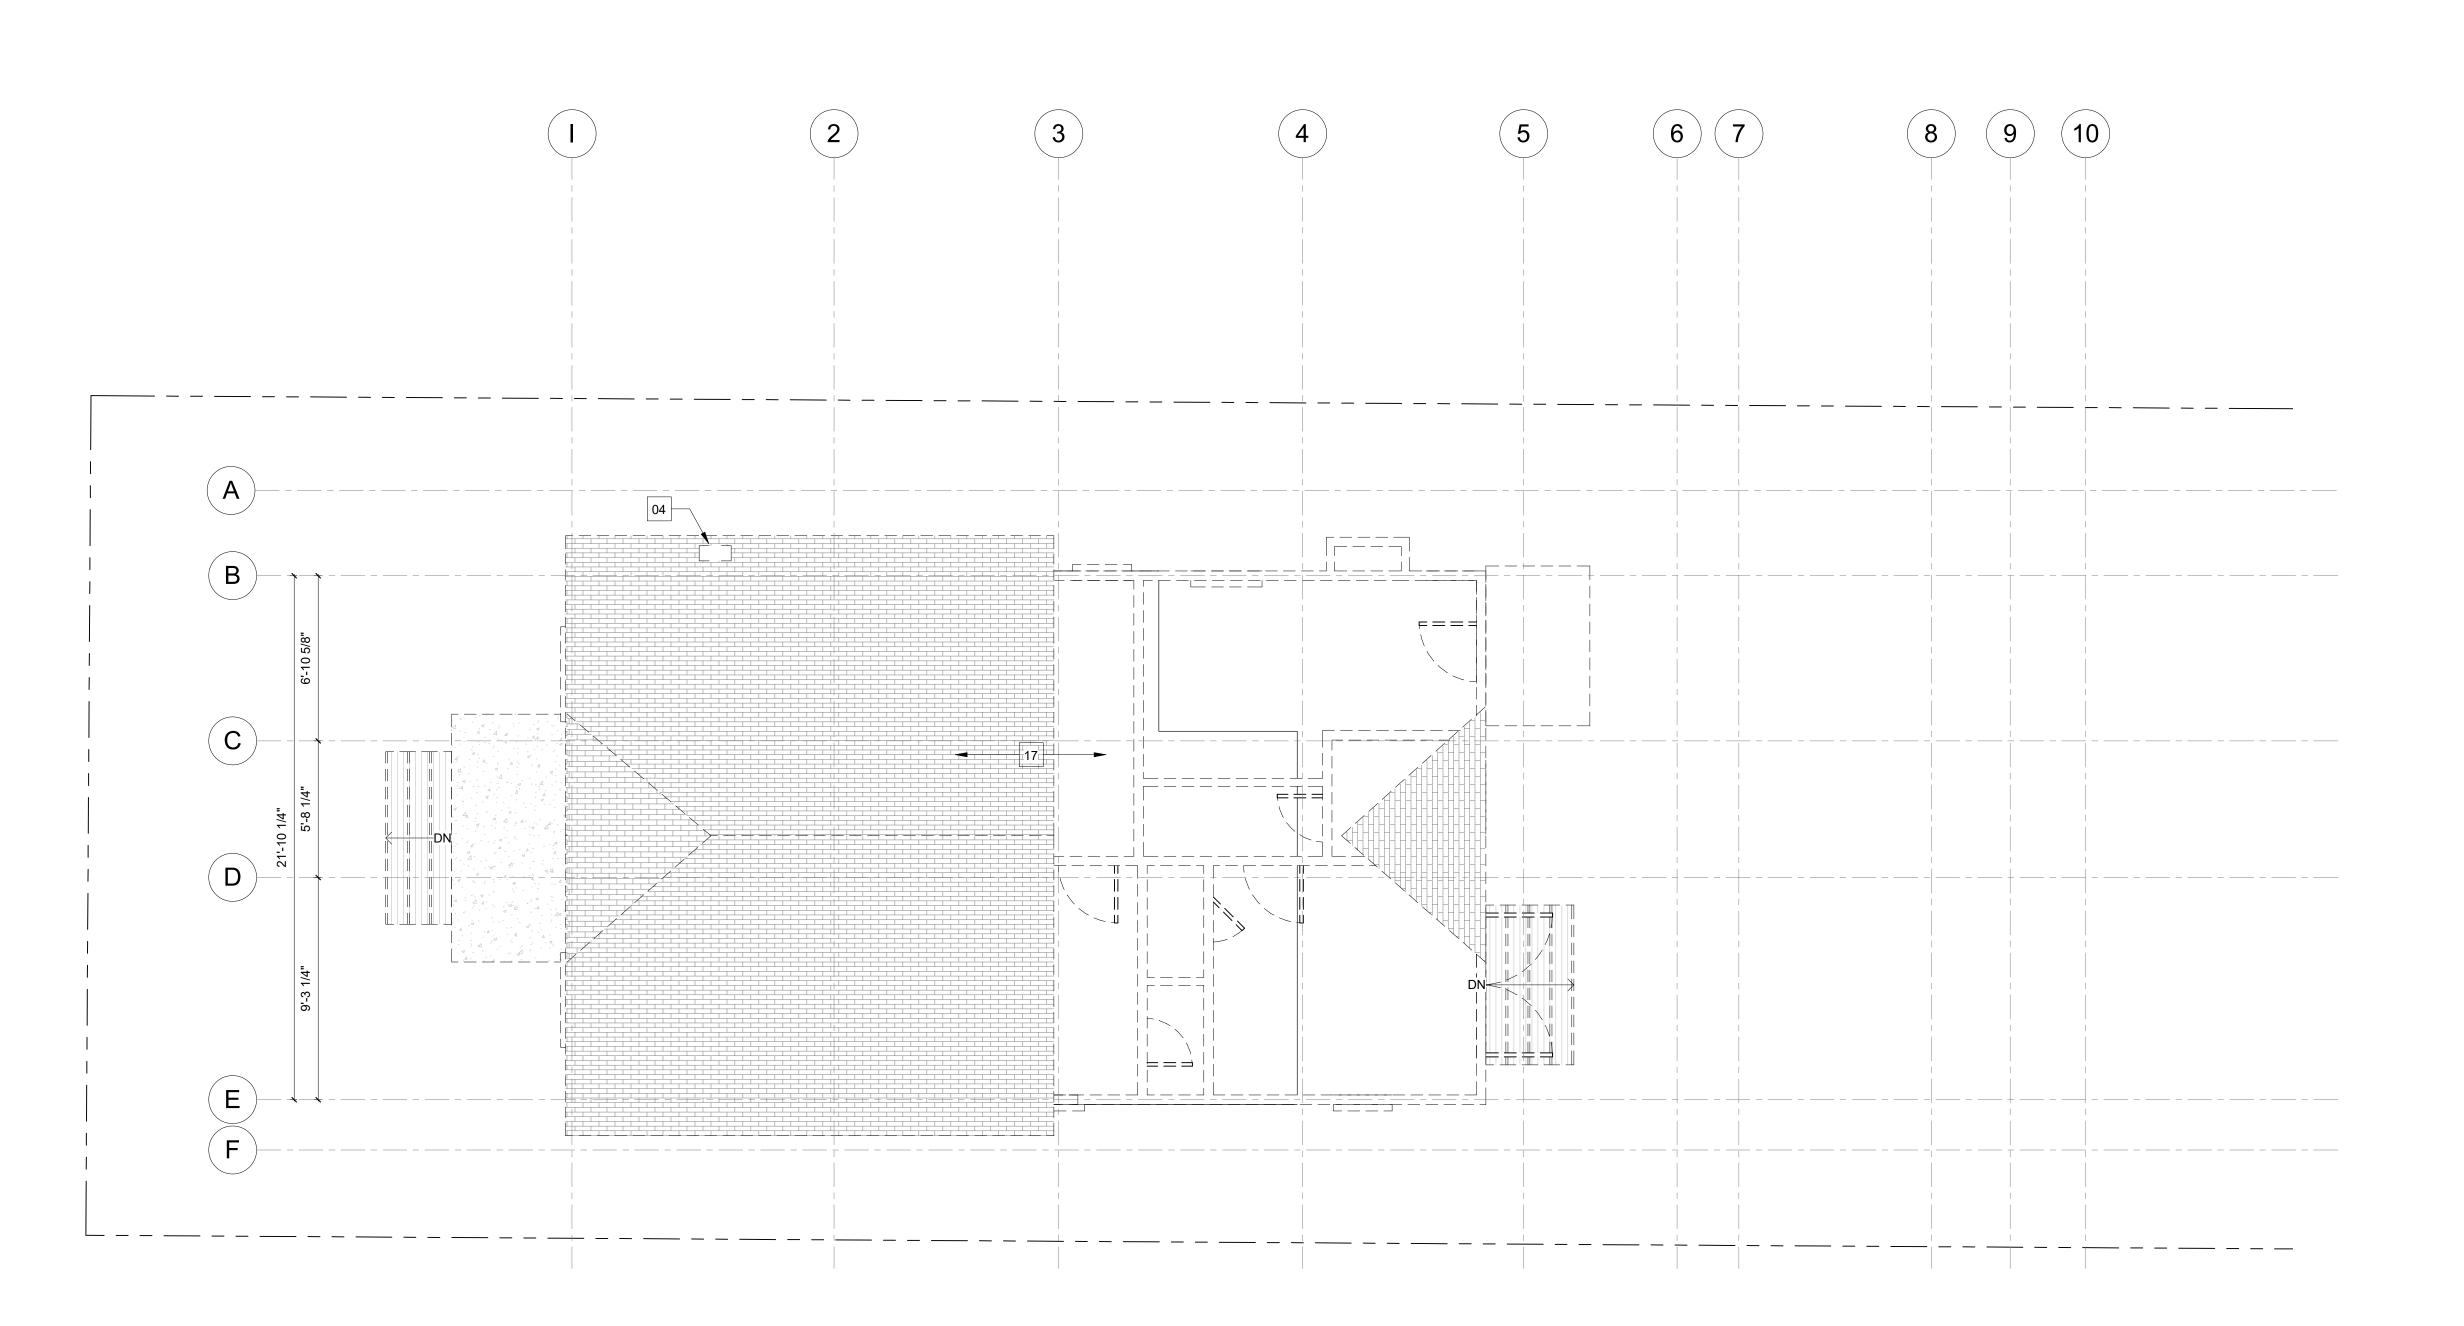

LEGEND

PARTITIONS

EXISTING TO REMAIN

TO BE DEMOLISHED

EXISTING ROOF TO REMAIN

DIMENSIONS

— FACE OF FINISH FACE OF FRAMING

CONSTRUCTION NOTES

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KEYNOTES - DEMO

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02 EXISTING OPENING TO REMAIN, REMOVE [E] WINDOW 03 REMOVE [E] DOOR REMOVE [E] DOOR

REMOVE [E] FIREPLACE & CHIMNEY 05 EXISTING OPENING TO REMAIN, REMOVE [E] DOOR

06 REMOVE [E] INTERIOR WALL

07 REMOVE [E] PLUMBING FIXTURES AND CABINETS

08 REMOVE [E] KITCHEN APPLIANCES, PLUMBING FIXTURES, FINISHES AND CABINETS 09 REMOVE [E] EXTERIOR STEPS AND LANDING 10 REMOVE [E] PORTION OF WALL & PREP FOR [N]

11 REMOVE [E] HEARTH & PREP FOR [N] FLOORING

12 REMOVE [E] EXTERIOR WALL

13 REMOVE [E] CABINETRY 14 REMOVE [E] SHELF & POLE

15 REMOVE [E] FRONT PORCH, POSTS & ROOF 16 REMOVE [E] EXTERIOR AIR CONDITIONER UNIT

17 REMOVE [E] ROOF FINISH & PREP FOR [N] ROOF

18 REMOVE [E] WASHER & DRYER

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DEMOLITION PLAN CALCULATIONS

EXTERIOR WALL LENGTH MAINTAINED = 62' -10" PERCENT OF EXTERIOR WALL MAINTAINED = 51.8%

EXISTING ROOF AREA MAINTAINED = 451.4 SF

PERCENT OF EXISTING ROOF MAINTAINED = 54%

STRUCTURAL ENGINEER: CRAIG PHILLIPS ENGINEERING & DESIGN 2123 VESTAL AVENUE LOS ANGELES, CA 90026 310.625.2325

2030 HYPERION AVE | LOS ANGELES, CA | 90027

PROJECT NAME

OWNER

2107

ARCHITECT

CONSULTANTS

Nikki Neuburger

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846 E. MILWOOD AVE _VENICE, CA 90291_

NEUBURGER RESIDENCE

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KEY PLAN

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1 06.01.2021 PERMIT SET

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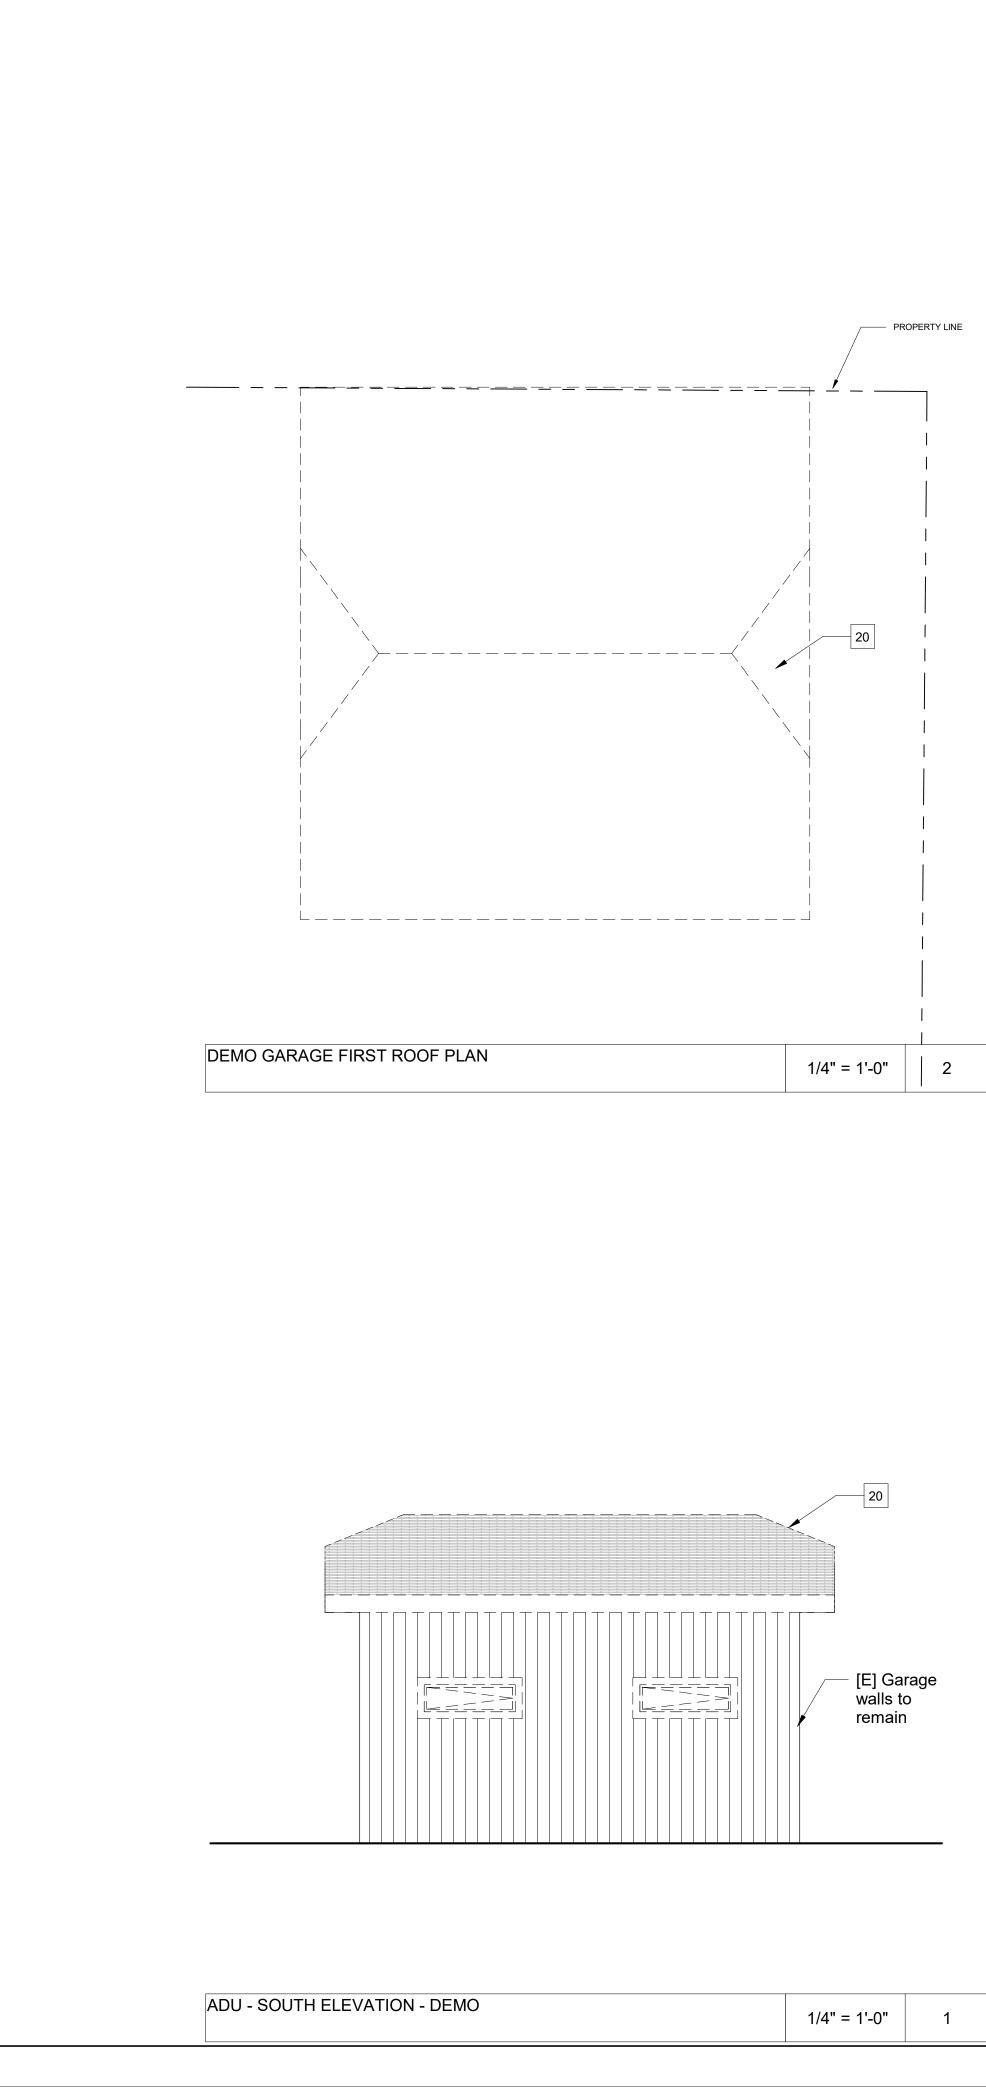
DEMO ROOF PLAN

SHEET NUMBER

EXISTING EXTERIOR WALL LENGTH = 121' - 1"

EXISTING ROOF AREA = 834.5 SF

DEMO ROOF PLAN



LEGEND

PARTITIONS

EXISTING TO REMAIN

TO BE DEMOLISHED

EXISTING ROOF TO REMAIN

DIMENSIONS

— FACE OF FINISH FACE OF FRAMING

CONSTRUCTION NOTES

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DEMOLITION PLAN CALCULATIONS

PROJECT NAME

OWNER

2107

ARCHITECT

CONSULTANTS

2123 VESTAL AVENUE

VALENCIA, CA 91355

GLENDALE, CA 91201

<u>TITLE 24:</u> NEWTON ENERGY

LOS ANGELES, CA 90026

26074 AVENUE HALL, SUITE 12

GEOTECHNICAL ENGINEER:

1545 VICTORY BLVD. 2ND FLOOR

1730 E. HOLLY AVE, SUITE 755 EL SEGUNDO, CA 90245

C-26132

KEY PLAN

SUBMITTAL RECORD

09/30/2021

DESIGN

310.625.2325

818.891.9100

GEOSYSTEMS

818.500.9533

310.375.2699

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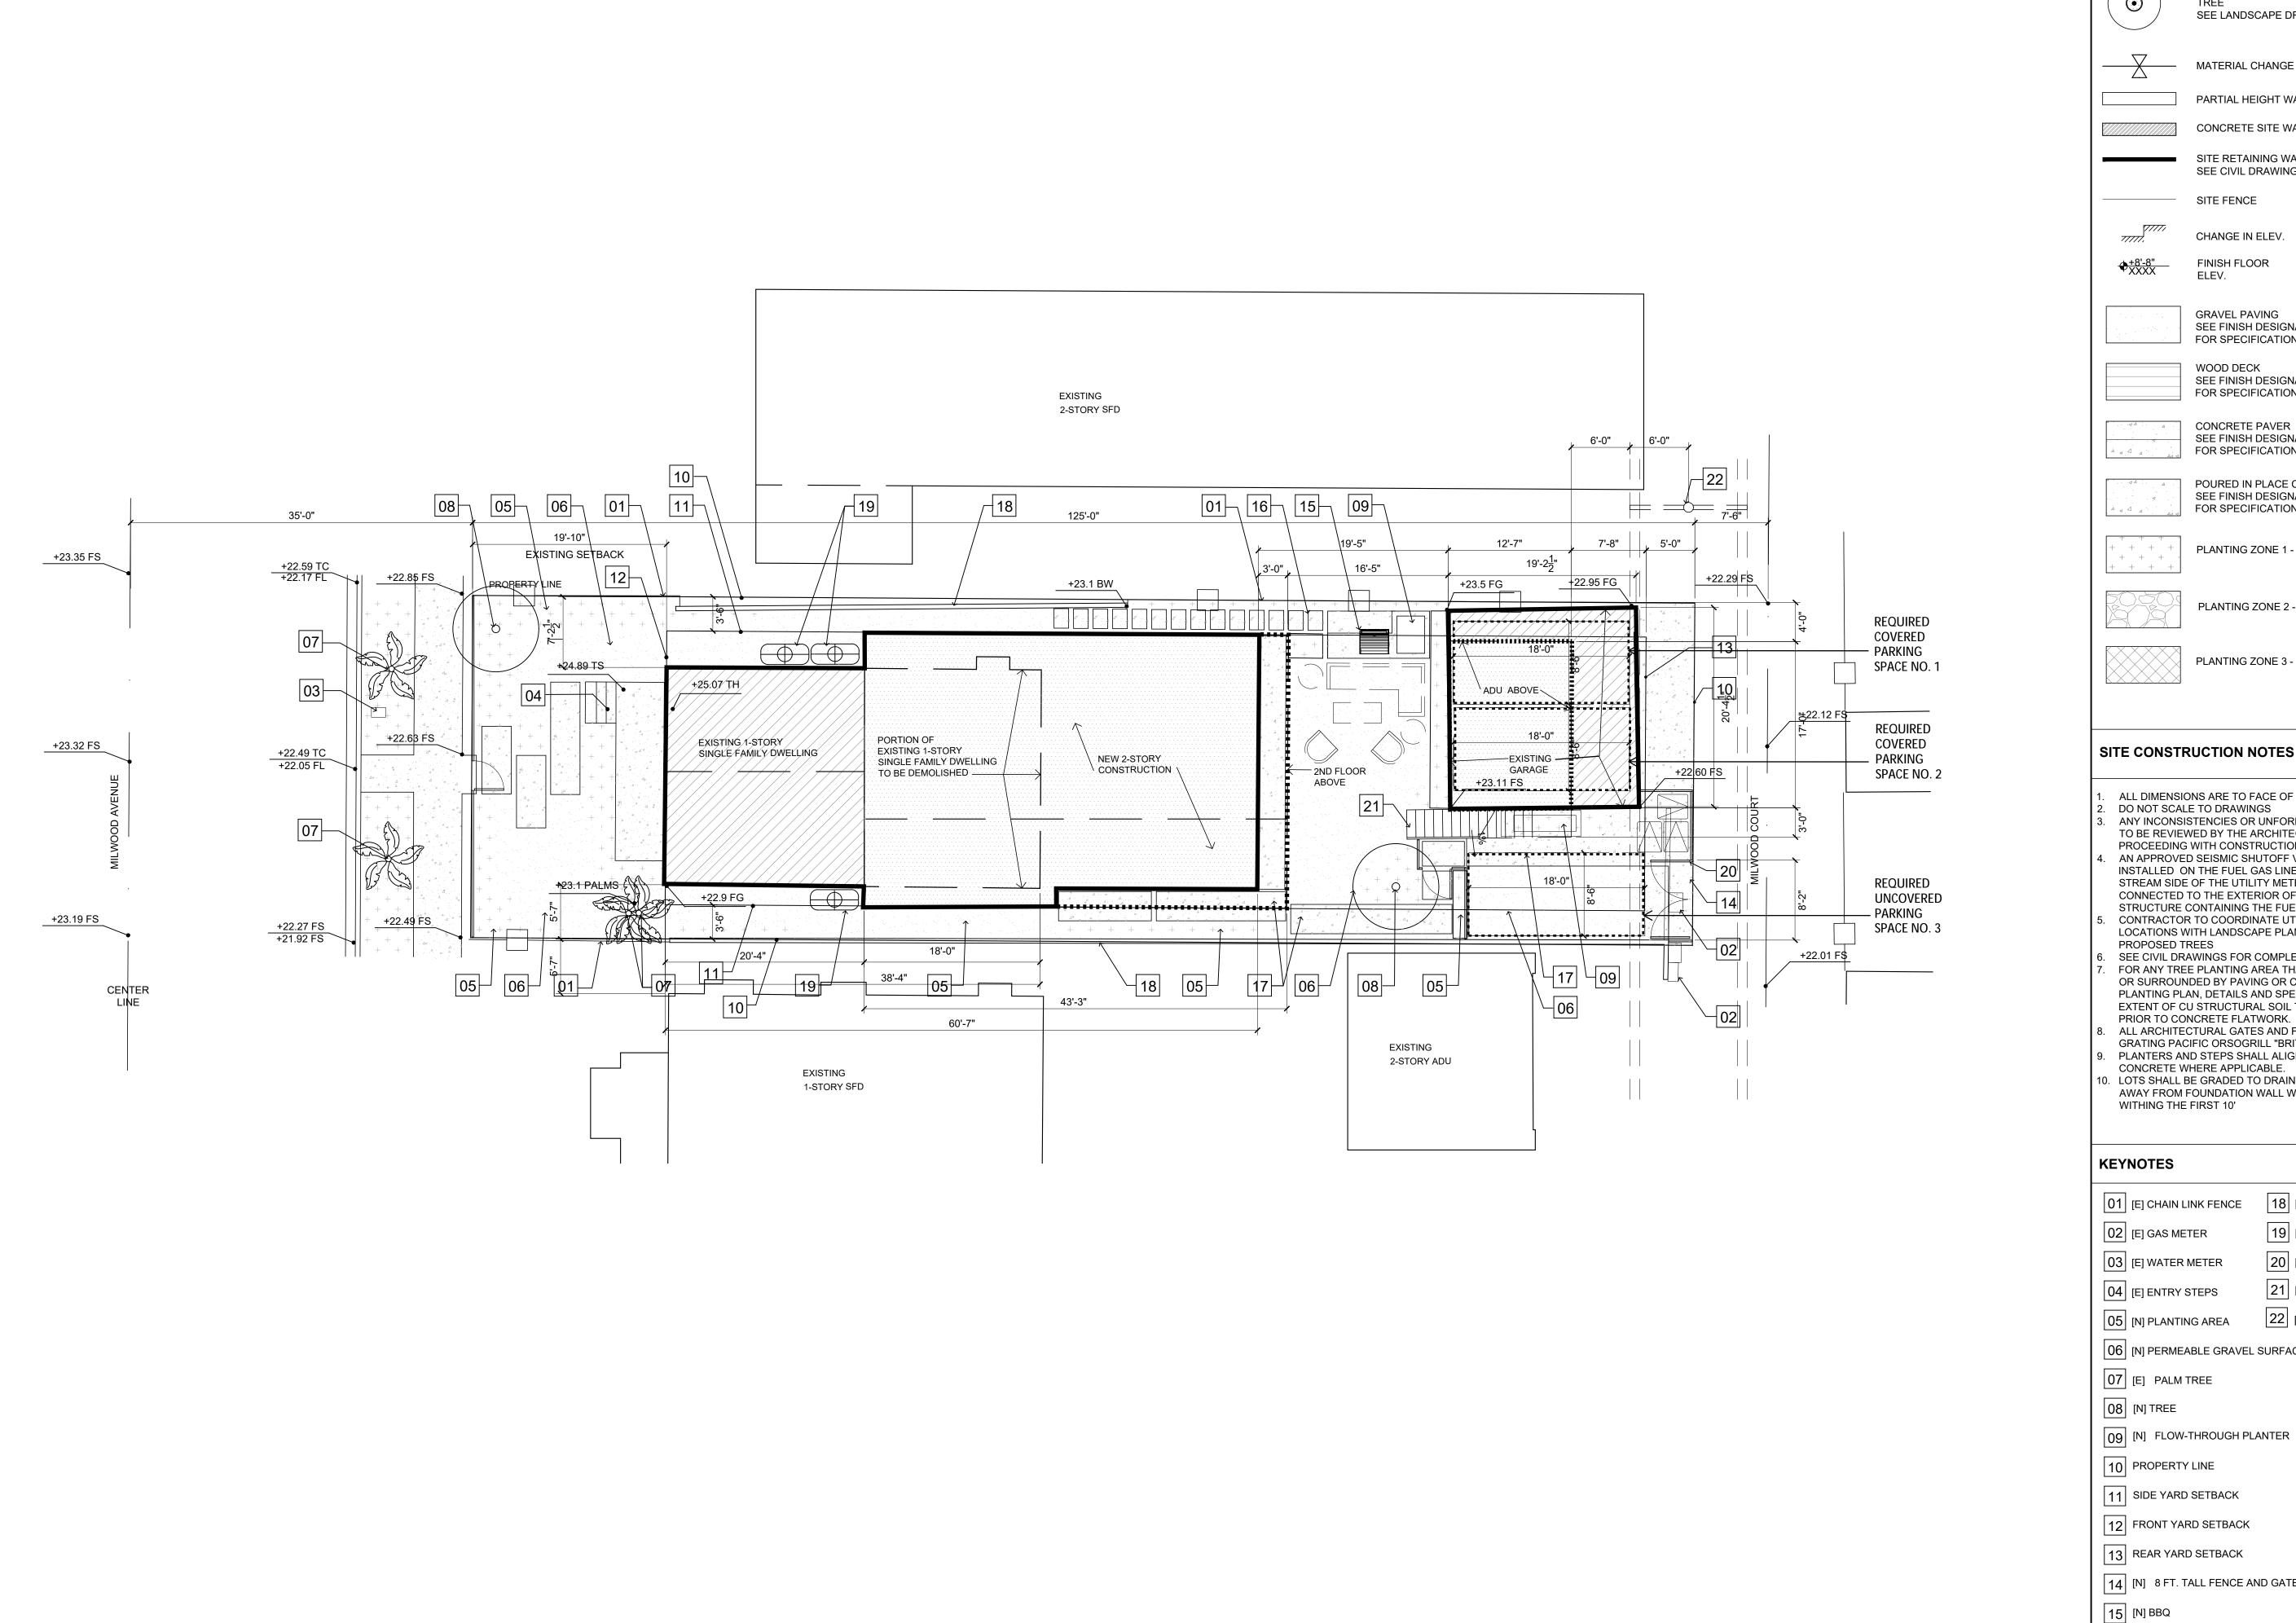
846 E. MILWOOD AVE _VENICE, CA 90291_

NEUBURGER RESIDENCE

SHEET NUMBER

SCALE 1/4" = 1'-0" DRAWING TITLE

DEMO GARAGE



SITE PLAN

PROJECT NAME & ADDRESS: LEGEND PROJECT ADDRESS PROJECT NUMBER: 2107 SEE LANDSCAPE DRAWINGS OWNER: MATERIAL CHANGE PARTIAL HEIGHT WALL ARCHITECT: CONCRETE SITE WALL SITE RETAINING WALL SEE CIVIL DRAWINGS IF APPLICABLE SITE FENCE CHANGE IN ELEV. 2030 HYPERION AVE | LOS ANGELES, CA | 90027 FINISH FLOOR CONSULTANTS: **GRAVEL PAVING** SEE FINISH DESIGNATION FOR SPECIFICATIONS WOOD DECK SEE FINISH DESIGNATION FOR SPECIFICATIONS CONCRETE PAVER SEE FINISH DESIGNATION FOR SPECIFICATIONS POURED IN PLACE CONCRETE SEE FINISH DESIGNATION FOR SPECIFICATIONS PLANTING ZONE 1 -PLANTING ZONE 2 -



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- PROCEEDING WITH CONSTRUCTION AN APPROVED SEISMIC SHUTOFF VALVE WILL BE INSTALLED ON THE FUEL GAS LINE ON THE DOWN STREAM SIDE OF THE UTILITY METER AND BE RIGIDLY CONNECTED TO THE EXTERIOR OF THE BUILDING OR STRUCTURE CONTAINING THE FUEL GAS PIPING CONTRACTOR TO COORDINATE UTILITY TRENCH LOCATIONS WITH LANDSCAPE PLANTING PLAN TO AVOID
- SEE CIVIL DRAWINGS FOR COMPLETE SPOT ELEVATIONS FOR ANY TREE PLANTING AREA THAT IS ADJACENT TO OR SURROUNDED BY PAVING OR CONCRETE, REFER TO PLANTING PLAN, DETAILS AND SPECIFICATIONS FOR THE EXTENT OF CU STRUCTURAL SOIL TO BE INSTALLED PRIOR TO CONCRETE FLATWORK.
- ALL ARCHITECTURAL GATES AND FENCING TO BE 6'H GRATING PACIFIC ORSOGRILL "BRITOSTEROPE" OPUS 50 PLANTERS AND STEPS SHALL ALIGN WITH SAWCUTS IN
- . LOTS SHALL BE GRADED TO DRAIN SURFACE WATER AWAY FROM FOUNDATION WALL WITH A MIN FALL OF 6"



SUBMITTAL RECORD:

01 04.##.2021 PERMIT SUBMITTAL

18 [E] CMU WALL

[N] RAIN WATER TANK

20 [N] AUTO GATE

21 [N] STAIR TO ADU [E] POWER POLE


06 [N] PERMEABLE GRAVEL SURFACE

14 [N] 8 FT. TALL FENCE AND GATE

1/8" = 1'-0"


16 [N] PRE-FAB CONC. PAVERS

17 [N] POURED IN PLACE CONCRETE

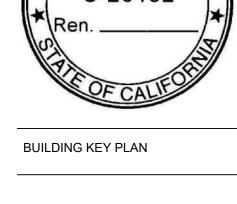

DRAWING TITLE SITE PLAN


1/8" = 1'-0"

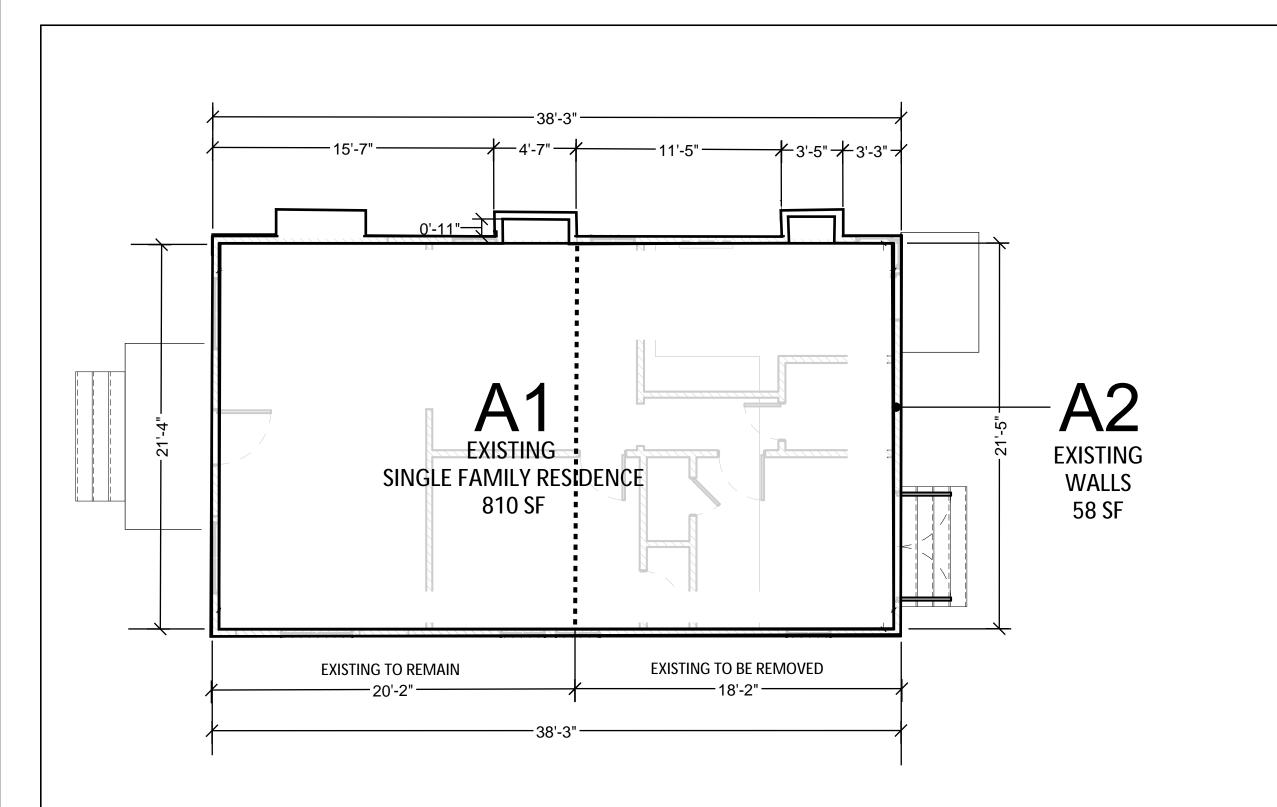

AREA OF REMODEL 435 SF

FIRST FLOOR

© PROPOSED FLOOR AREA CALCULATIONS

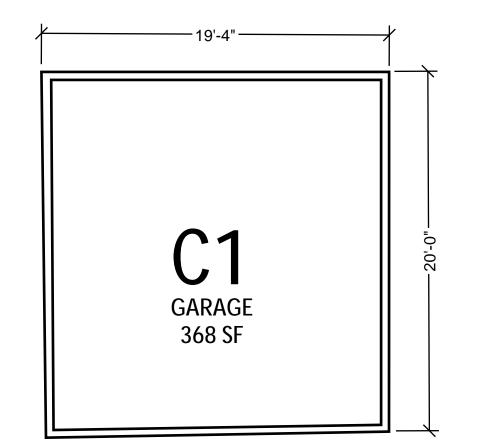

GARAGE 368 SF

	EXISTING FLOOR AREA CALCULATIONS							
NO.	AREA		SQUARE	ZONING	BUILDING	SCHOOL	RFA	NOTES
			FEET	DEFINITION	CODE	FEE		
A1	[E] FLOOR AREA		810	YES	YES	YES	YES	
A2	[E] EXTERIOR WALLS		58			YES		
C1	[E] DETACHED GARAGE		368		YES			
		TOTALS	1,236 SF	810 SF	1,178 SF	868 SF	810 SF	

EXISTING WALLS TO REN	AIN EXISTING WALLS TO BE REMOVED
15'-7" 11" 4'-7" 11" 21'-4" + 20'-2"	11'-5" 3'-5" 3'-3" 21'-5" + 8'-2"
63'-6"	> GREATER THAN 50% 57'-8" OF LINEAR WALL TO REMAIN

3/16" = 1'-0"

NOTES

TITLE 24:
NEWTON ENERGY
1730 E. HOLLY AVE, SUITE 755
EL SEGUNDO, CA 90245
310.375.2699

PROJECT NAME

VENICE, CA 90291

PROJECT NUMBER

2030 HYPERION AVE | LOS ANGELES, CA | 90027

STRUCTURAL ENGINEER: CRAIG PHILLIPS ENGINEERING &

26074 AVENUE HALL, SUITE 12

GEOTECHNICAL ENGINEER: GEOSYSTEMS 1545 VICTORY BLVD. 2ND FLOOR GLENDALE, CA 91201 818.500.9533

Nikki Neuburger

OWNER

2107

ARCHITECT

CONSULTANTS

2123 VESTAL AVENUE LOS ANGELES, CA 90026 310.625.2325

VALENCIA, CA 91355

818.891.9100

DESIGN

NEUBURGER RESIDENCE 846 E. MILWOOD AVE

C-26132

Ren.

OF CALIFORN

ARCHY

MSED ARCHY

ARCHY

MODEL OF CALIFORN

OF CALIFOR

KEY PLAN

SUBMITTAL RECORD

1 | 06.01.2021 | PERMIT SET


SCALE
3/16" = 1'-0"

DRAWING TITLE

FLOOR AREA BREAKDOWN

SHEET NUMBER

A050

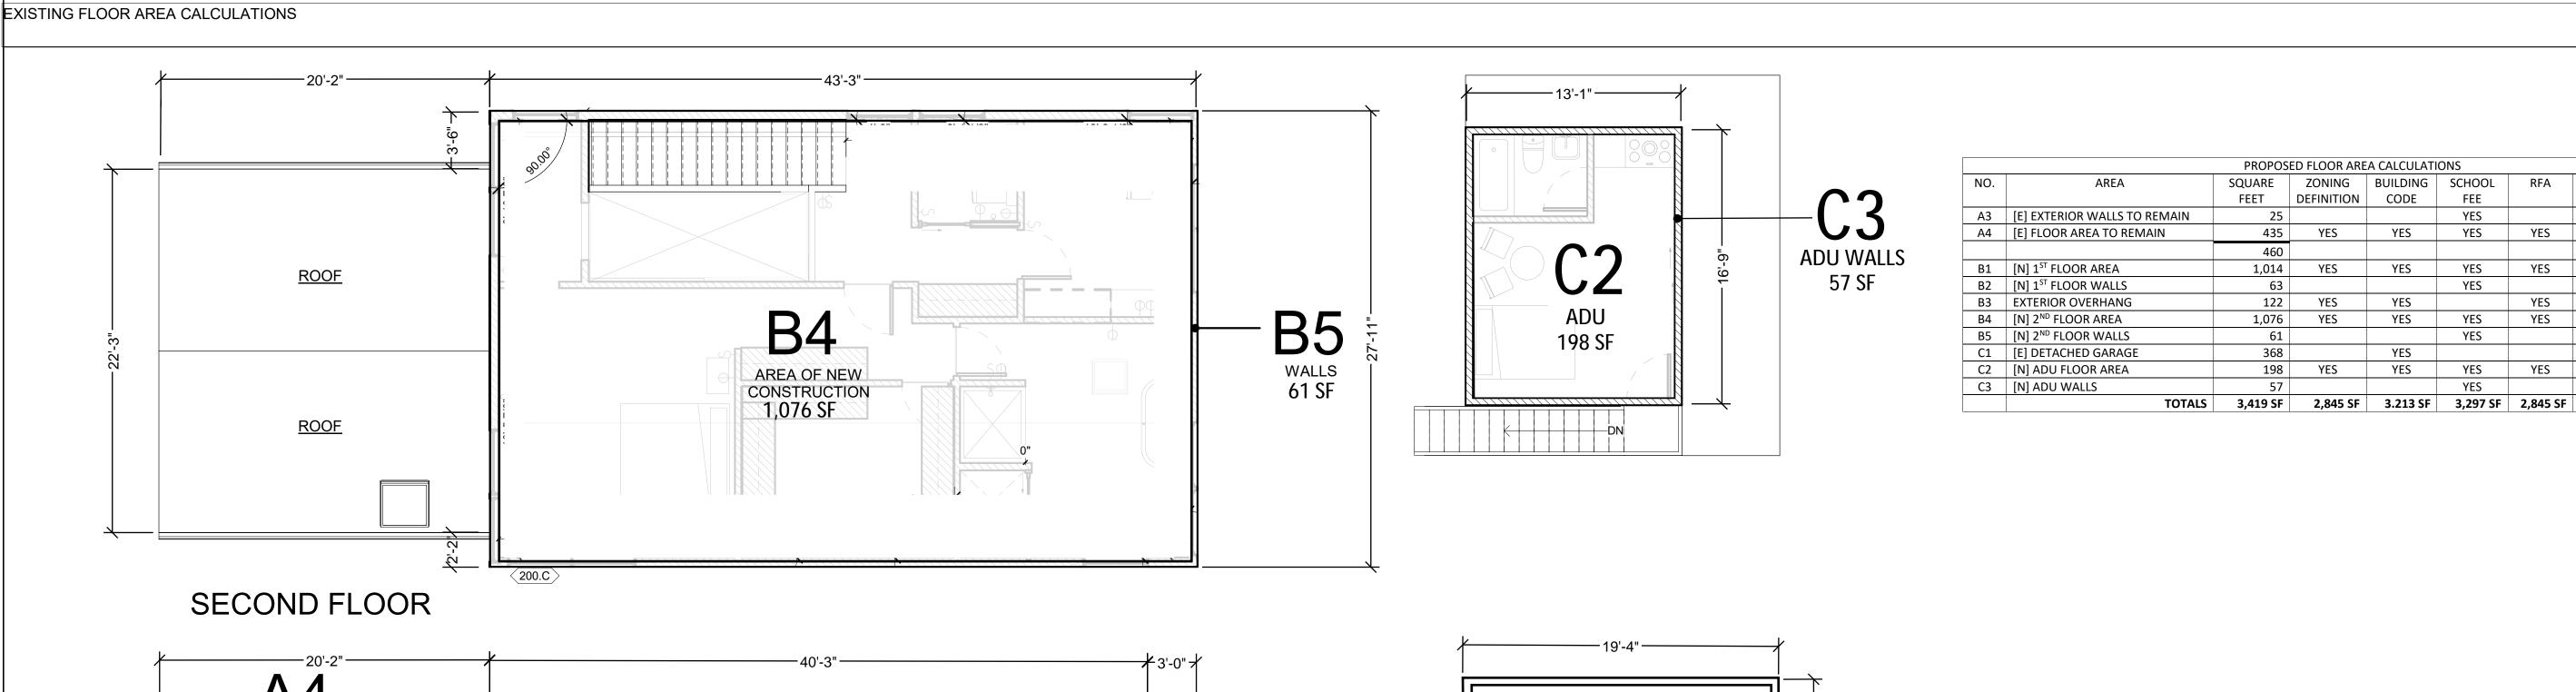

B2

WALLS 63 SF

B3


AREA UNDERNEATH OVERHANG 122 SF

B1

AREA OF NEW CONSTRUCTION 1,014 SF

3/16" = 1'-0"


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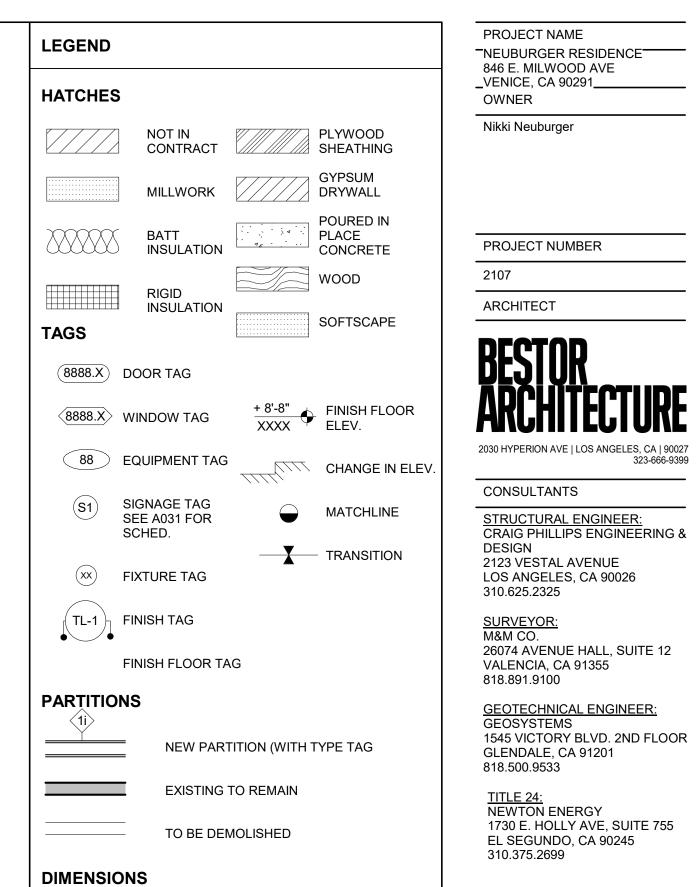


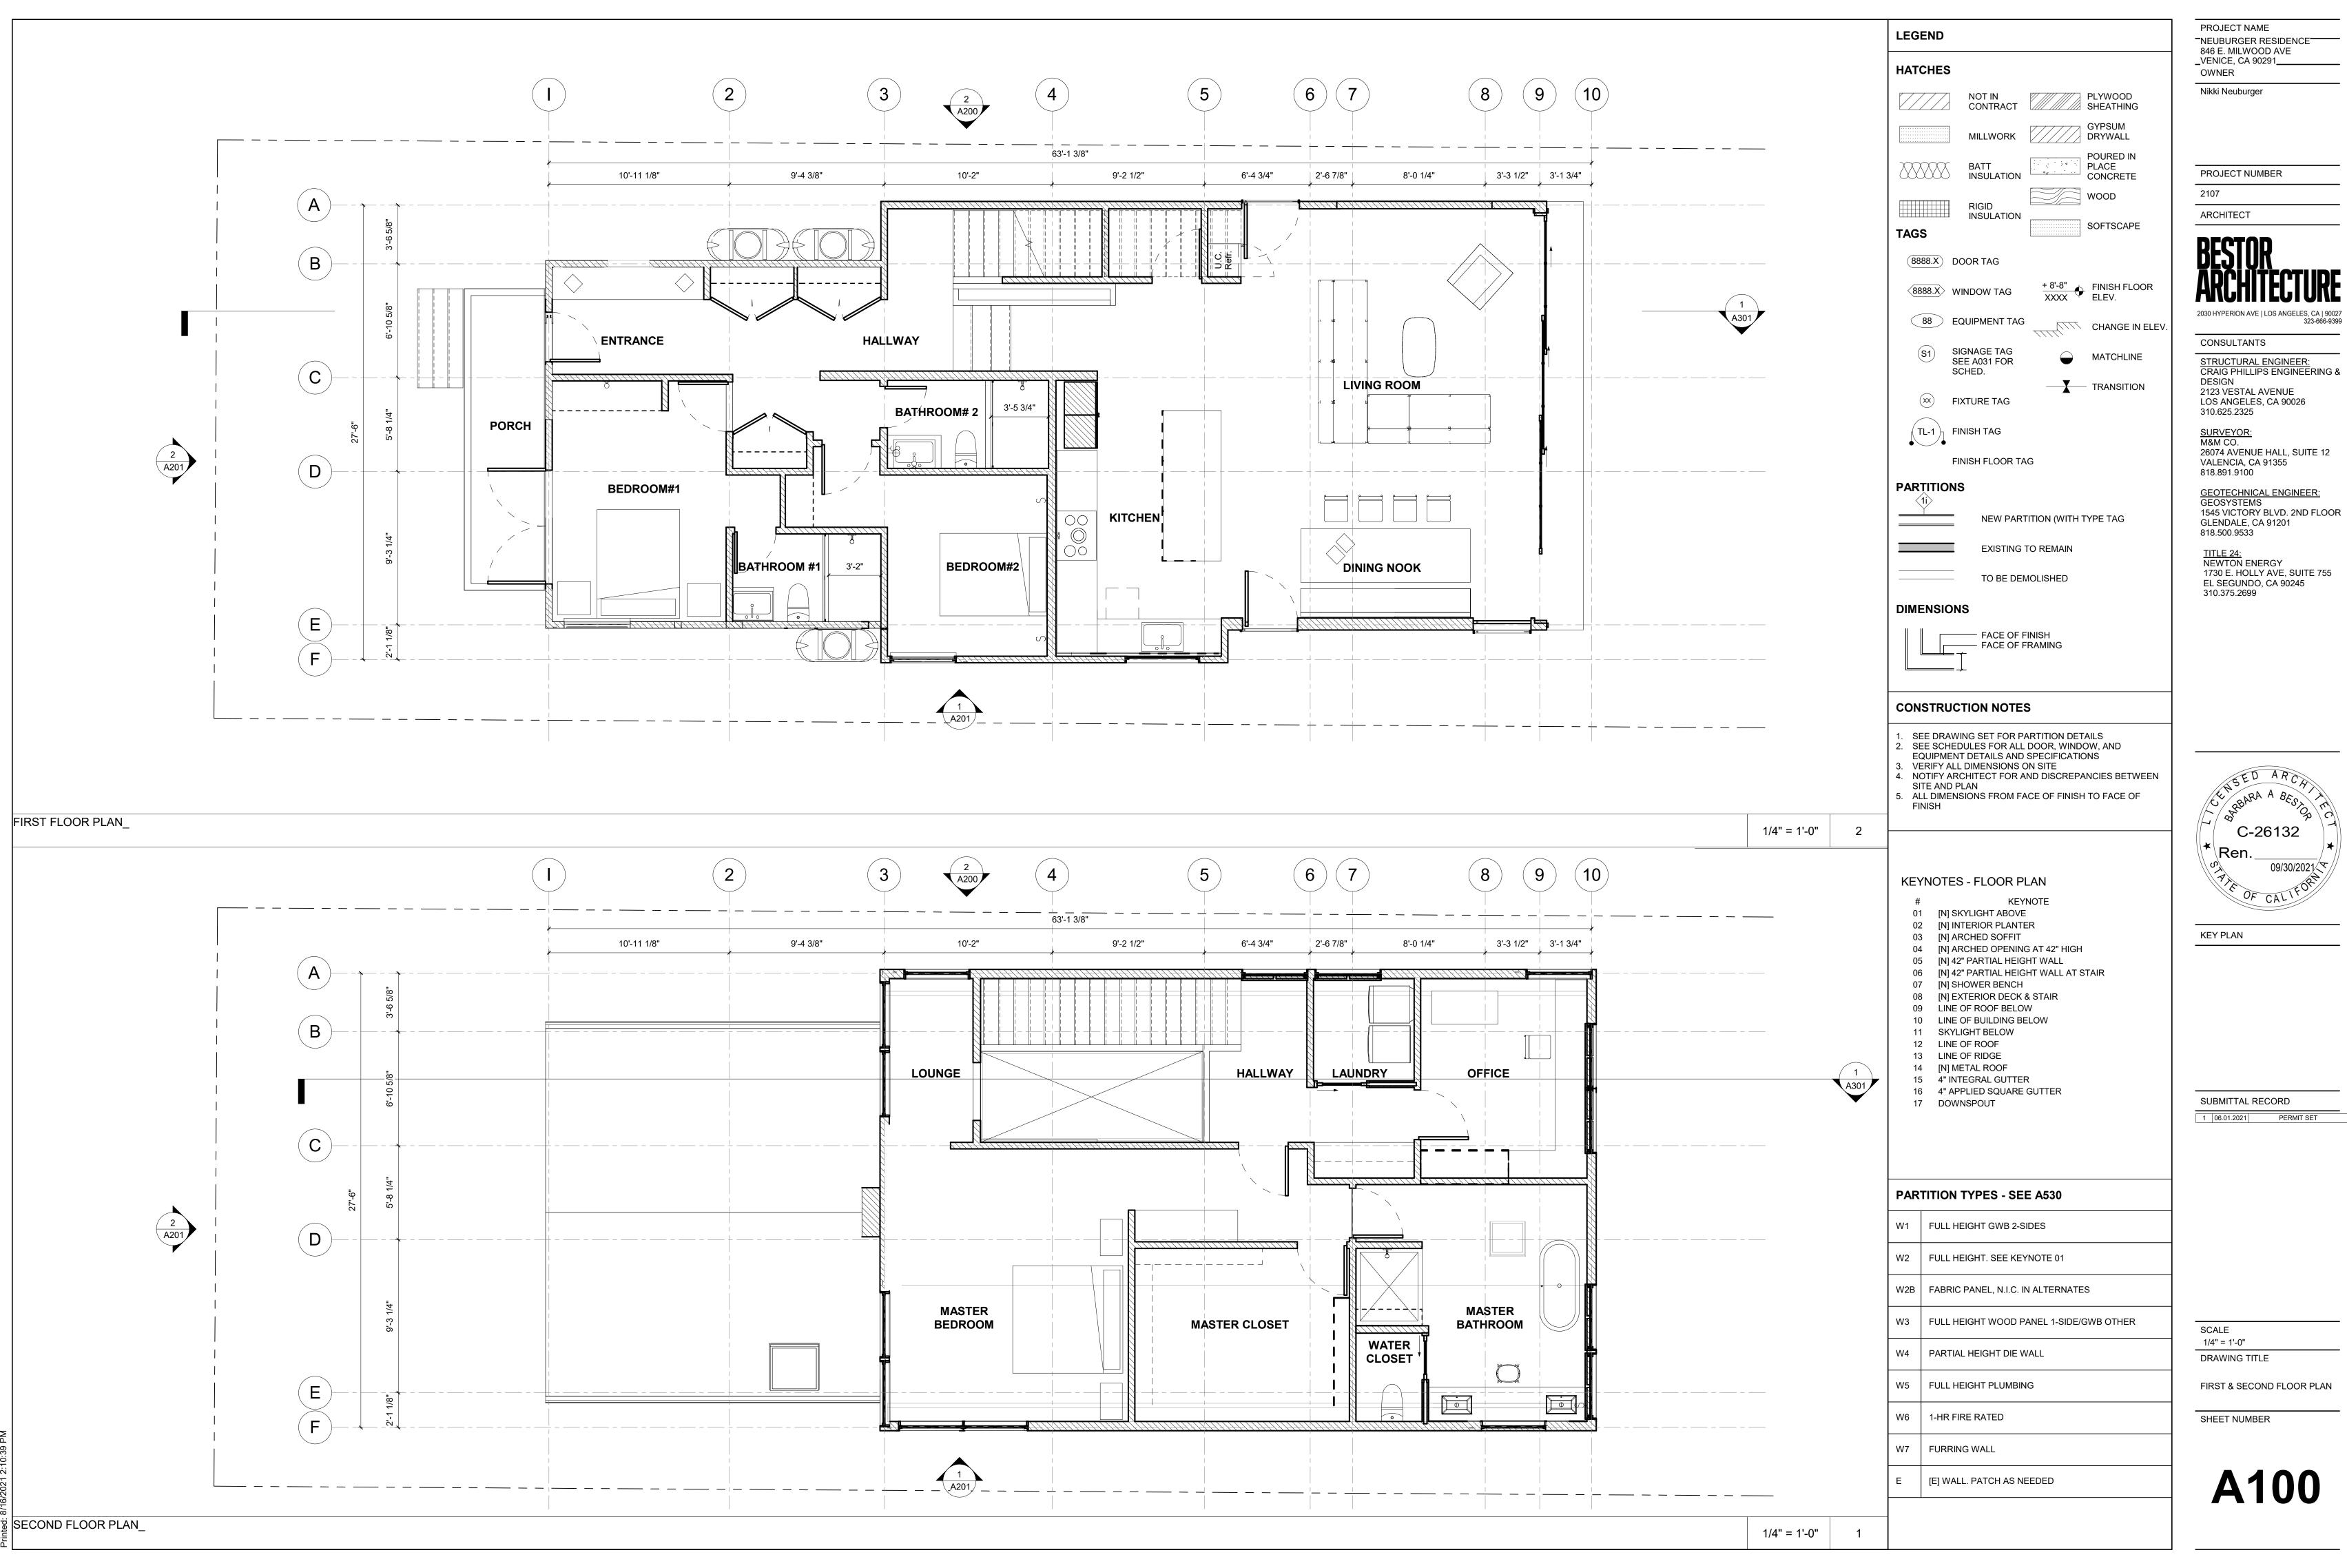TNEUBURGER RESIDENCE 846 E. MILWOOD AVE

STRUCTURAL ENGINEER: CRAIG PHILLIPS ENGINEERING &

C-26132



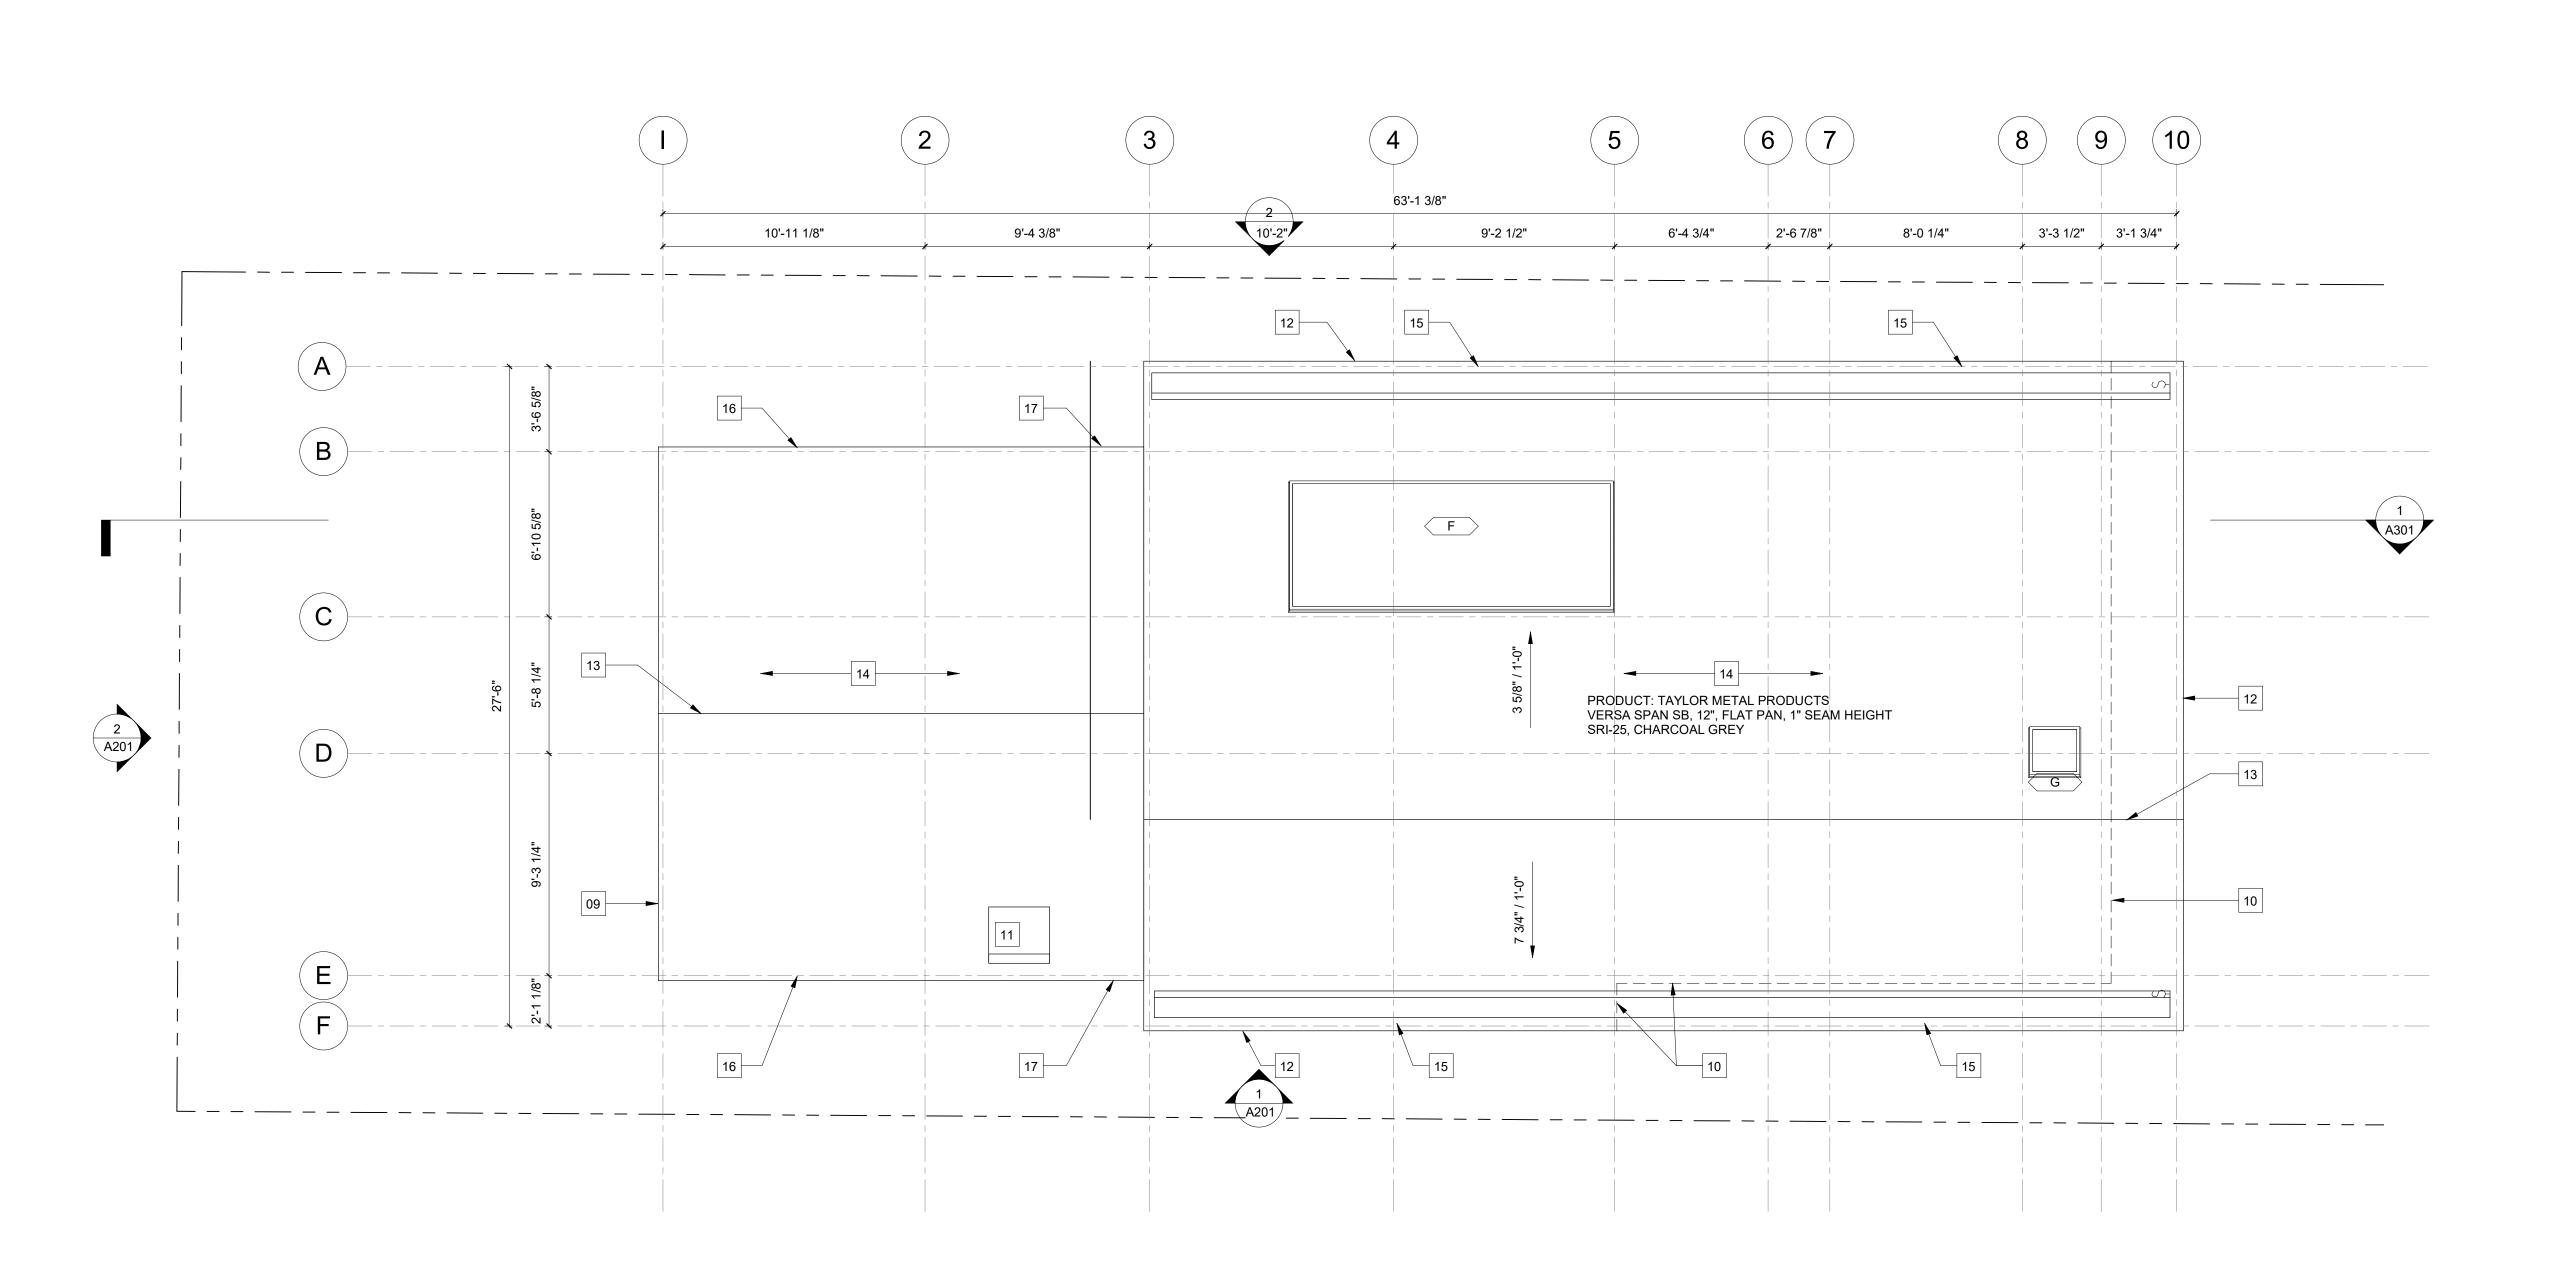

CONSTRUCTION NOTES

SEE DRAWING SET FOR PARTITION DETAILS

FACE OF FINISH FACE OF FRAMING

- SEE SCHEDULES FOR ALL DOOR, WINDOW, AND EQUIPMENT DETAILS AND SPECIFICATIONS
 VERIFY ALL DIMENSIONS ON SITE 4. NOTIFY ARCHITECT FOR AND DISCREPANCIES BETWEEN SITE AND PLAN
- 5. ALL DIMENSIONS FROM FACE OF FINISH TO FACE OF FINISH

KEYNOTES - FLOOR PLAN

- [N] SKYLIGHT ABOVE [N] INTERIOR PLANTER
- [N] ARCHED SOFFIT
- 04 [N] ARCHED OPENING AT 42" HIGH 05 [N] 42" PARTIAL HEIGHT WALL
- 06 [N] 42" PARTIAL HEIGHT WALL AT STAIR 07 [N] SHOWER BENCH
- 08 [N] EXTERIOR DECK & STAIR
- 09 LINE OF ROOF BELOW
- 10 LINE OF BUILDING BELOW
- 11 SKYLIGHT BELOW
- 12 LINE OF ROOF13 LINE OF RIDGE
- 14 [N] METAL ROOF
- 15 4" INTEGRAL GUTTER
 16 4" APPLIED SQUARE GUTTER
- 17 DOWNSPOUT

C-26132 \|*\Ren.

KEY PLAN

PROJECT NAME

OWNER

2107

ARCHITECT

CONSULTANTS

2123 VESTAL AVENUE

VALENCIA, CA 91355

DESIGN

SURVEYOR: M&M CO.

818.891.9100

818.500.9533

Nikki Neuburger

PROJECT NUMBER

2030 HYPERION AVE | LOS ANGELES, CA | 90027

STRUCTURAL ENGINEER: CRAIG PHILLIPS ENGINEERING &

26074 AVENUE HALL, SUITE 12

SUBMITTAL RECORD

1 06.01.2021 PERMIT SET


SCALE 1/4" = 1'-0" DRAWING TITLE


ROOF PLAN


SHEET NUMBER

1/4" = 1'-0"

ROOF PLAN

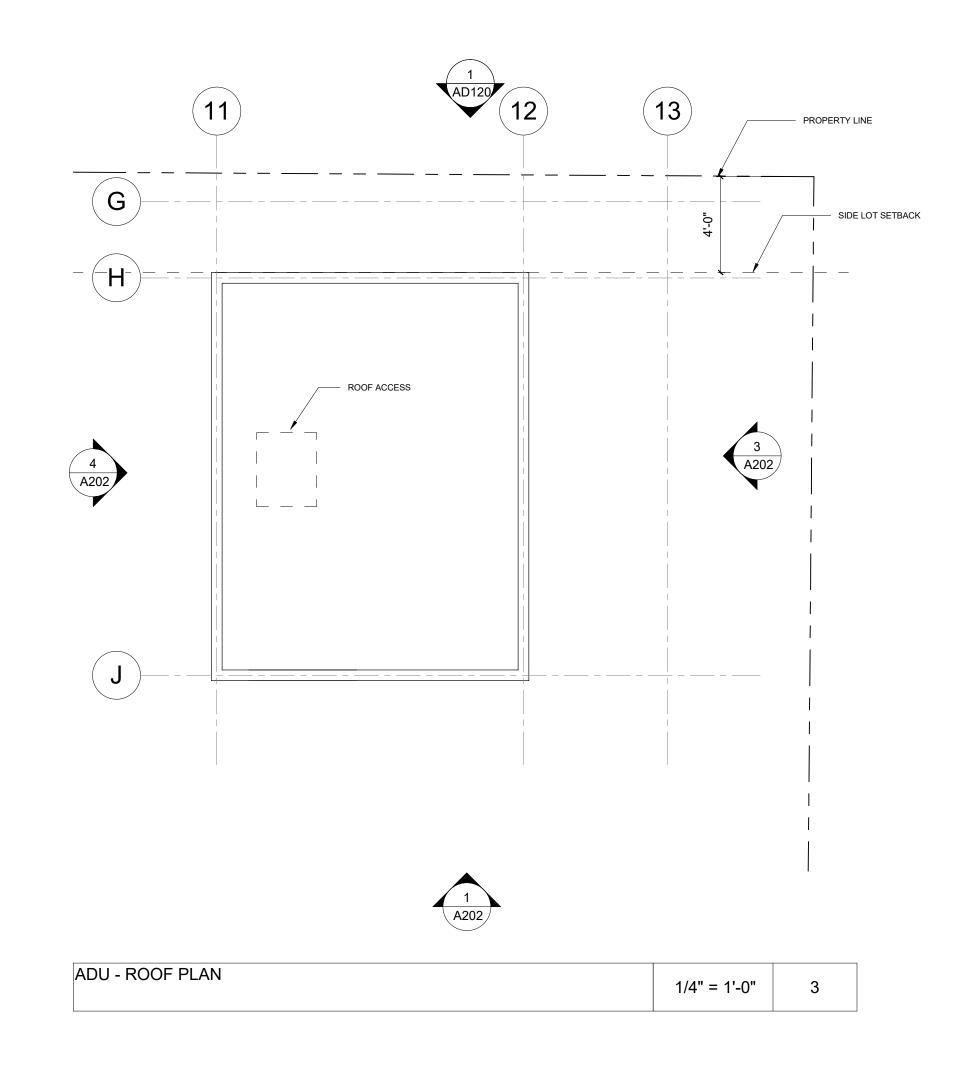


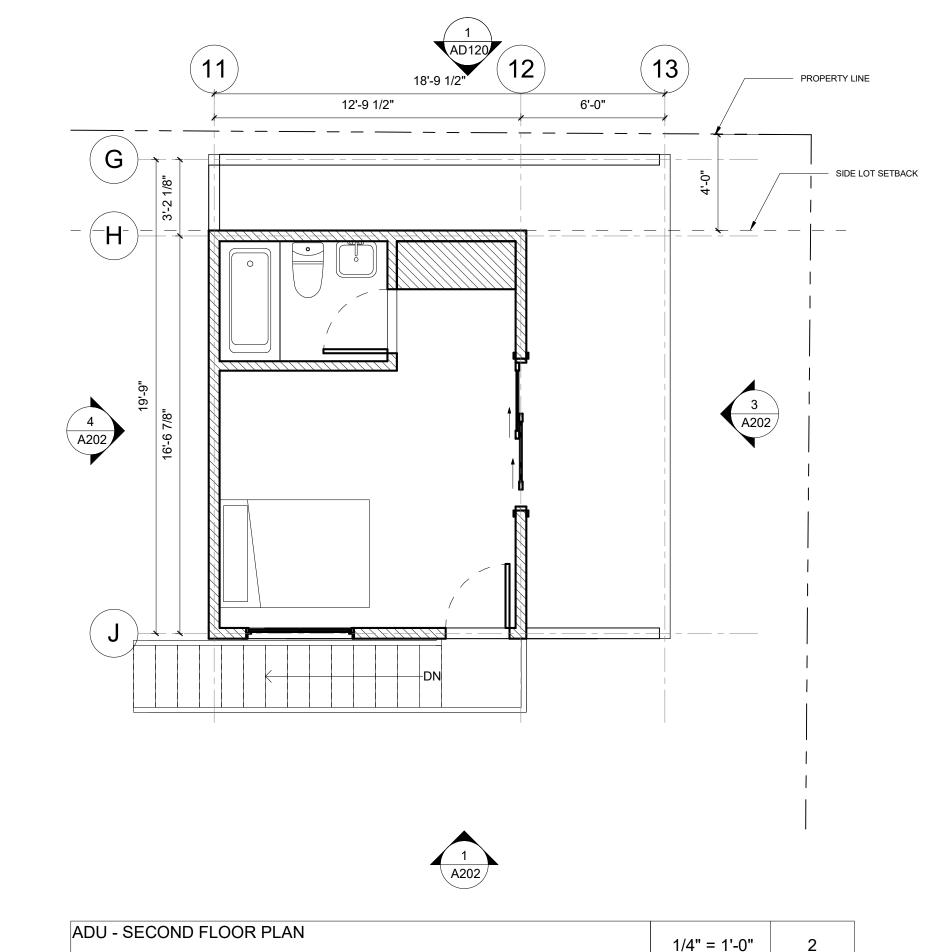

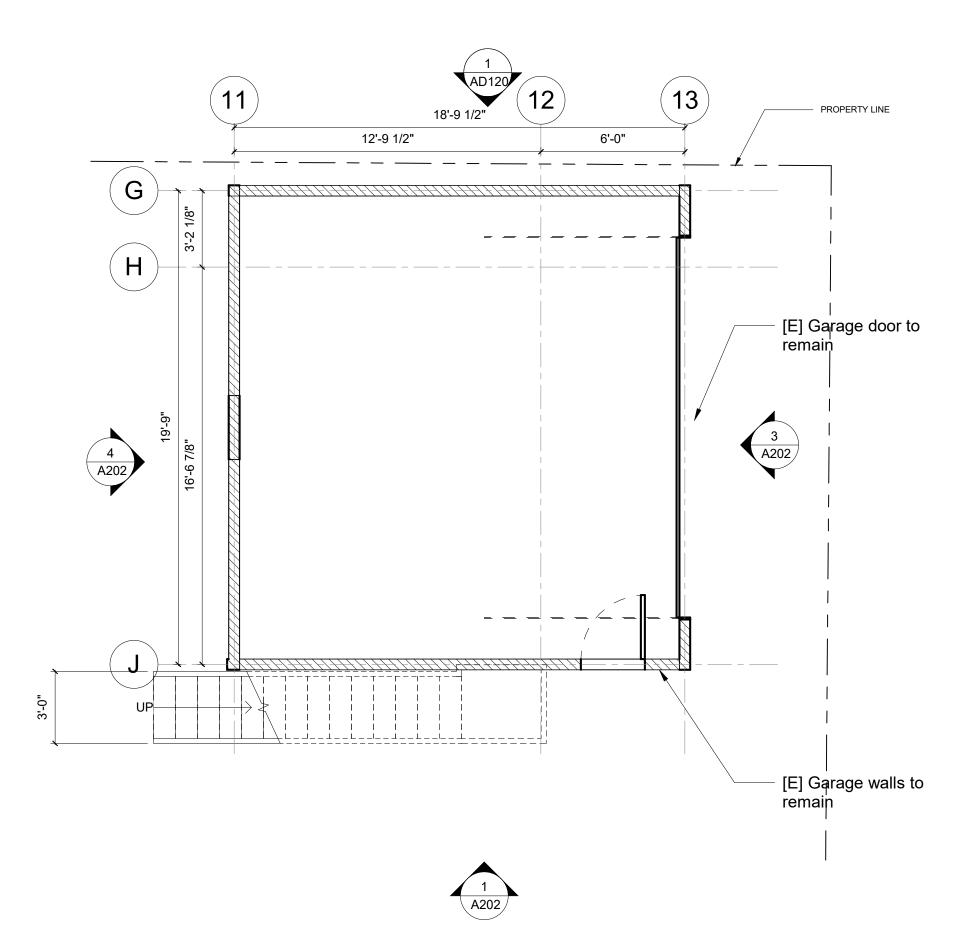

1/4" = 1'-0"

ADU - FIRST FLOOR PLAN

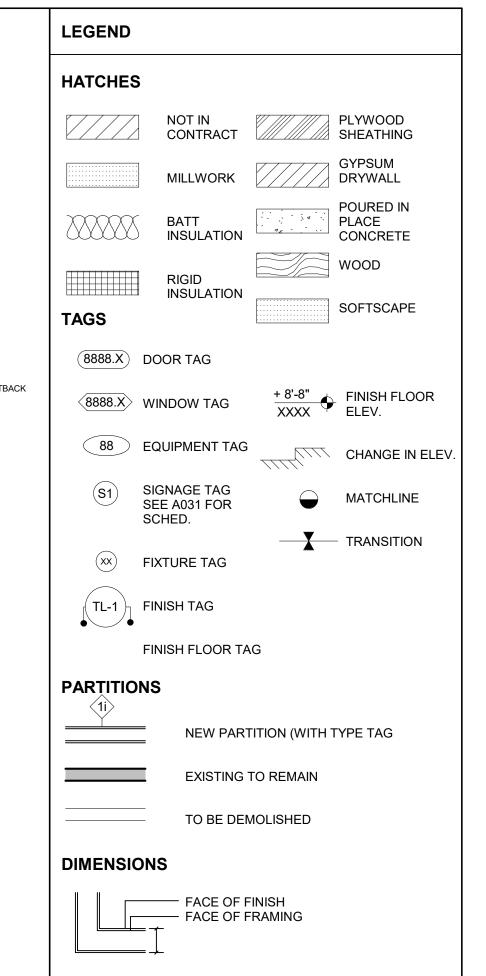

CONSTRUCTION NOTES

- 1. SEE DRAWING SET FOR PARTITION DETAILS
 2. SEE SCHEDULES FOR ALL DOOR, WINDOW, AND EQUIPMENT DETAILS AND SPECIFICATIONS
 3. VERIFY ALL DIMENSIONS ON SITE
 4. NOTIFY ARCHITECT FOR AND DISCREPANCIES BETWEEN SITE AND PLAN
- 5. ALL DIMENSIONS FROM FACE OF FINISH TO FACE OF
- FINISH

KEYNOTES - FLOOR PLAN

- KEYNOTE
- 01 [N] SKYLIGHT ABOVE 02 [N] INTERIOR PLANTER
- 03 [N] ARCHED SOFFIT
- 04 [N] ARCHED OPENING AT 42" HIGH 05 [N] 42" PARTIAL HEIGHT WALL
- 06 [N] 42" PARTIAL HEIGHT WALL AT STAIR
- 07 [N] SHOWER BENCH
- 08 [N] EXTERIOR DECK & STAIR
 09 LINE OF ROOF BELOW
- 10 LINE OF BUILDING BELOW 11 SKYLIGHT BELOW
- 12 LINE OF ROOF
- 13 LINE OF RIDGE
- 14 [N] METAL ROOF15 4" INTEGRAL GUTTER
- 16 4" APPLIED SQUARE GUTTER
- 17 DOWNSPOUT

PARTITION TYPES - SEE A530

W1	FULL HEIGHT GWB 2-SIDES
W2	FULL HEIGHT. SEE KEYNOTE 01
W2B	FABRIC PANEL, N.I.C. IN ALTERNATES
W3	FULL HEIGHT WOOD PANEL 1-SIDE/GWB OTHER
W4	PARTIAL HEIGHT DIE WALL
W5	FULL HEIGHT PLUMBING
W6	1-HR FIRE RATED
W7	FURRING WALL
E	[E] WALL. PATCH AS NEEDED

PROJECT NAME NEUBURGER RESIDENCE 846 E. MILWOOD AVE _VENICE, CA 90291_ OWNER

Nikki Neuburger

PROJECT NUMBER

2107 ARCHITECT

2030 HYPERION AVE | LOS ANGELES, CA | 90027 323-666-9399

CONSULTANTS STRUCTURAL ENGINEER: CRAIG PHILLIPS ENGINEERING & DESIGN 2123 VESTAL AVENUE LOS ANGELES, CA 90026 310.625.2325

26074 AVENUE HALL, SUITE 12 VALENCIA, CA 91355 818.891.9100

GEOTECHNICAL ENGINEER: GEOSYSTEMS 1545 VICTORY BLVD. 2ND FLOOR GLENDALE, CA 91201 818.500.9533

TITLE 24: NEWTON ENERGY 1730 E. HOLLY AVE, SUITE 755 EL SEGUNDO, CA 90245 310.375.2699




SUBMITTAL RECORD

KEY PLAN

SCALE 1/4" = 1'-0"

ADU - PLANS

DRAWING TITLE

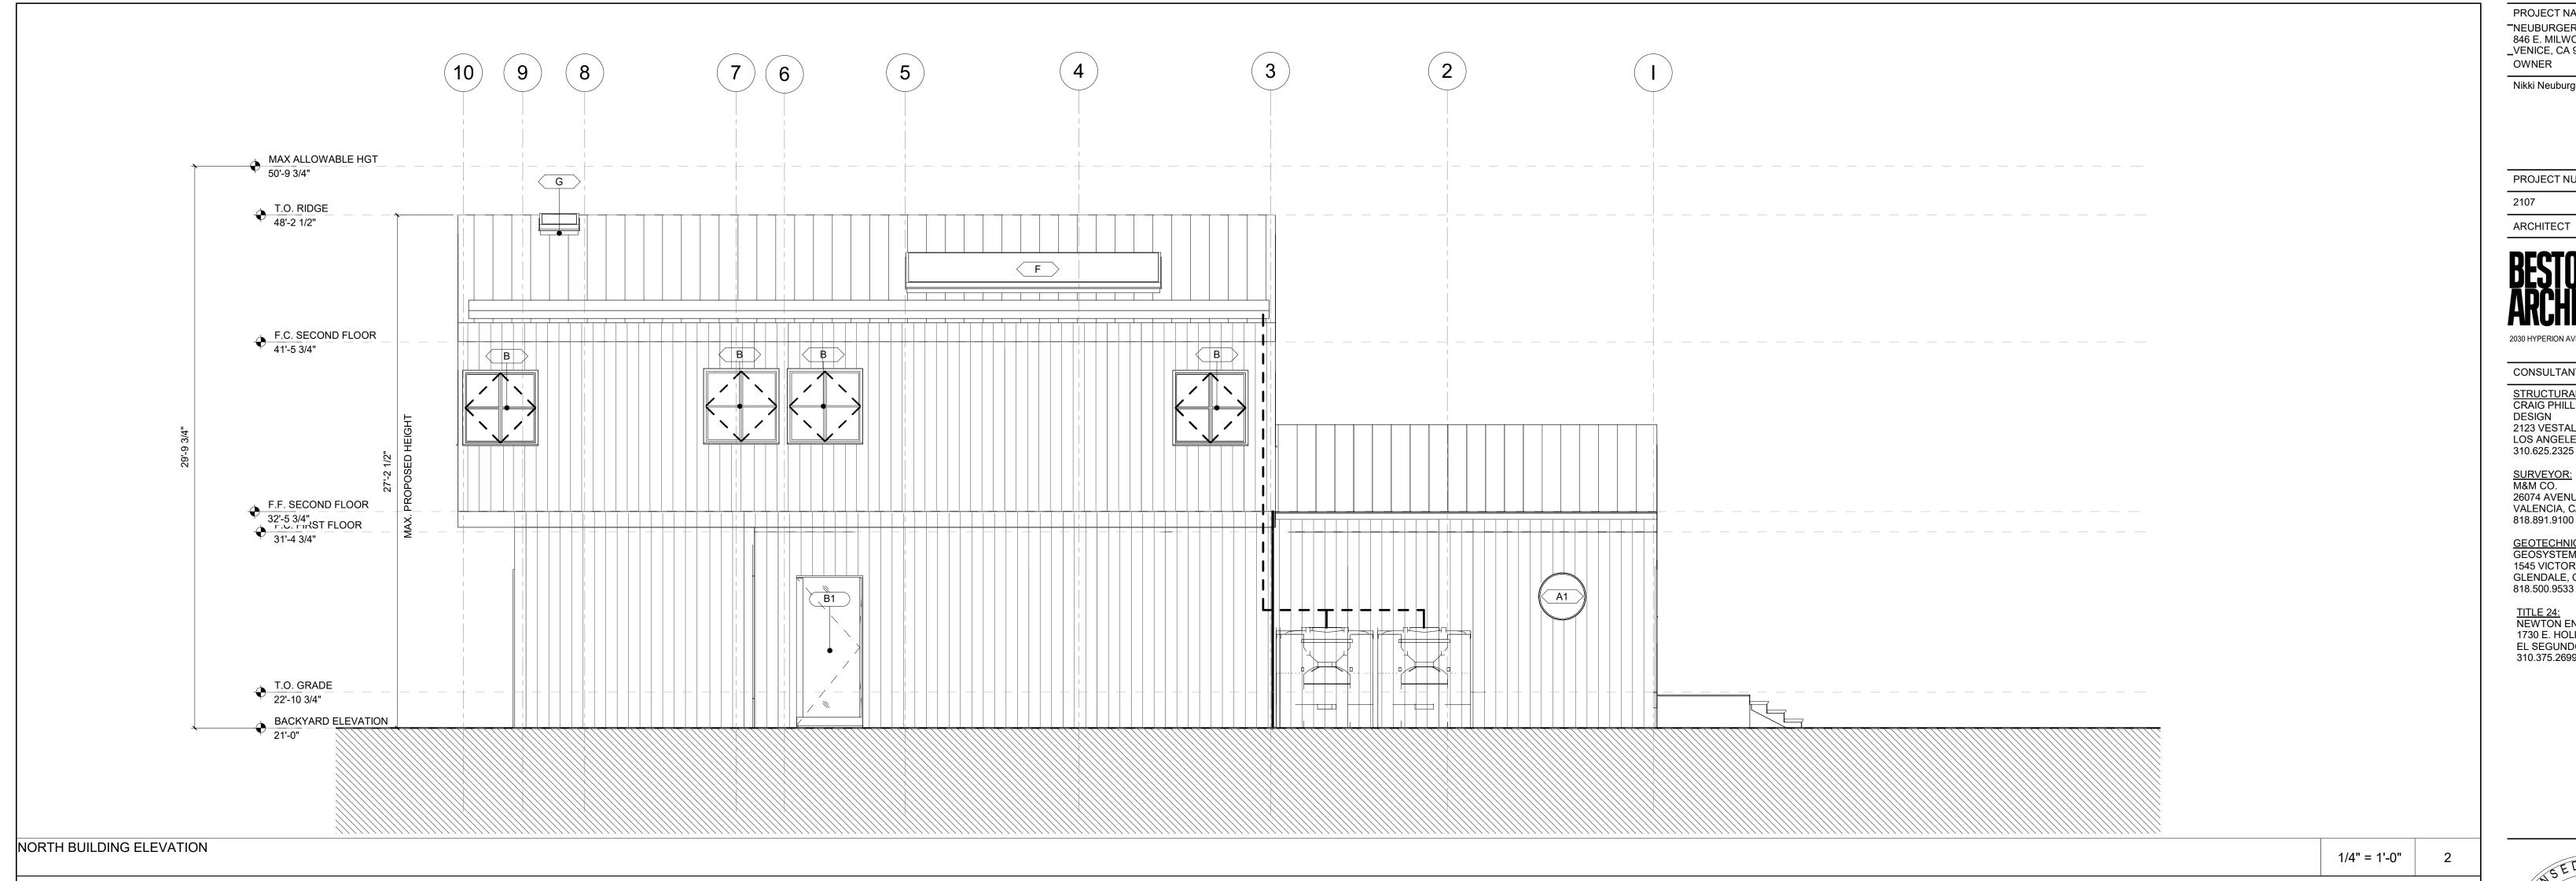

FE В A MAX ALLOWABLE HGT 50'-9 3/4" 7 1/4" F.C. SECOND FLOOR
41'-5 3/4" F.F. SECOND FLOOR

32'-5 3/4"

F.C. FIRST FLOOR

31'-4 3/4" ______D1 T.O. GRADE 22'-10 3/4" BACKYARD ELEVATION

PROJECT NAME NEUBURGER RESIDENCE 846 E. MILWOOD AVE _VENICE, CA 90291_____ OWNER

Nikki Neuburger

PROJECT NUMBER

2030 HYPERION AVE | LOS ANGELES, CA | 90027 323-666-9399

CONSULTANTS

STRUCTURAL ENGINEER:
CRAIG PHILLIPS ENGINEERING &
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2123 VESTAL AVENUE
LOS ANGELES, CA 90026
310.625.2325

SURVEYOR: M&M CO. 26074 AVENUE HALL, SUITE 12 VALENCIA, CA 91355 818.891.9100

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C-26132

KEY PLAN

SUBMITTAL RECORD 1 06.01.2021 PERMIT SET

SCALE 1/4" = 1'-0"


DRAWING TITLE

SHEET NUMBER

BUILDING ELEVATIONS

EAST BUILDING ELEVATION

1/4" = 1'-0"

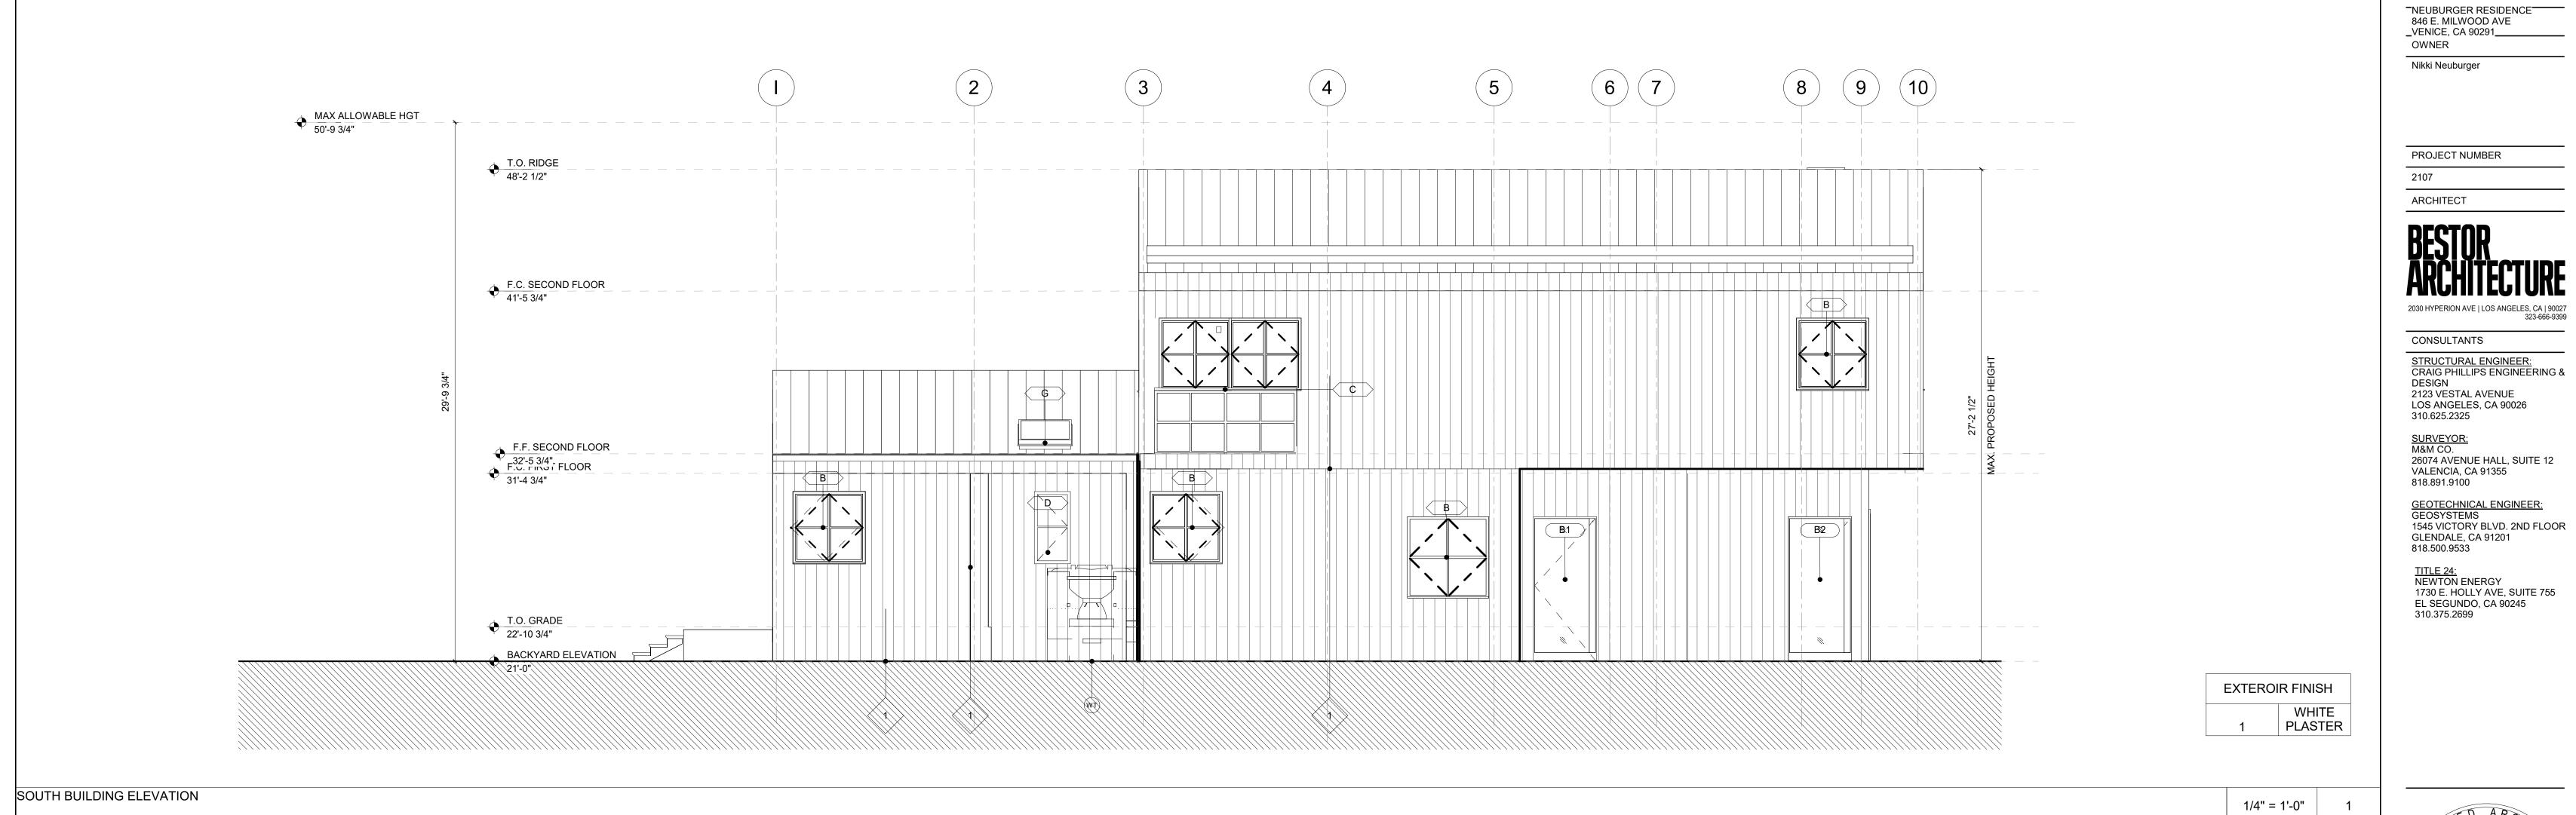

g WEST BUILDING ELEVATION

PROJECT NAME

KEY PLAN

 SUBMITTAL RECORD

 1 | 06.01.2021 | PERMIT SET

SCALE

1/4" = 1'-0"


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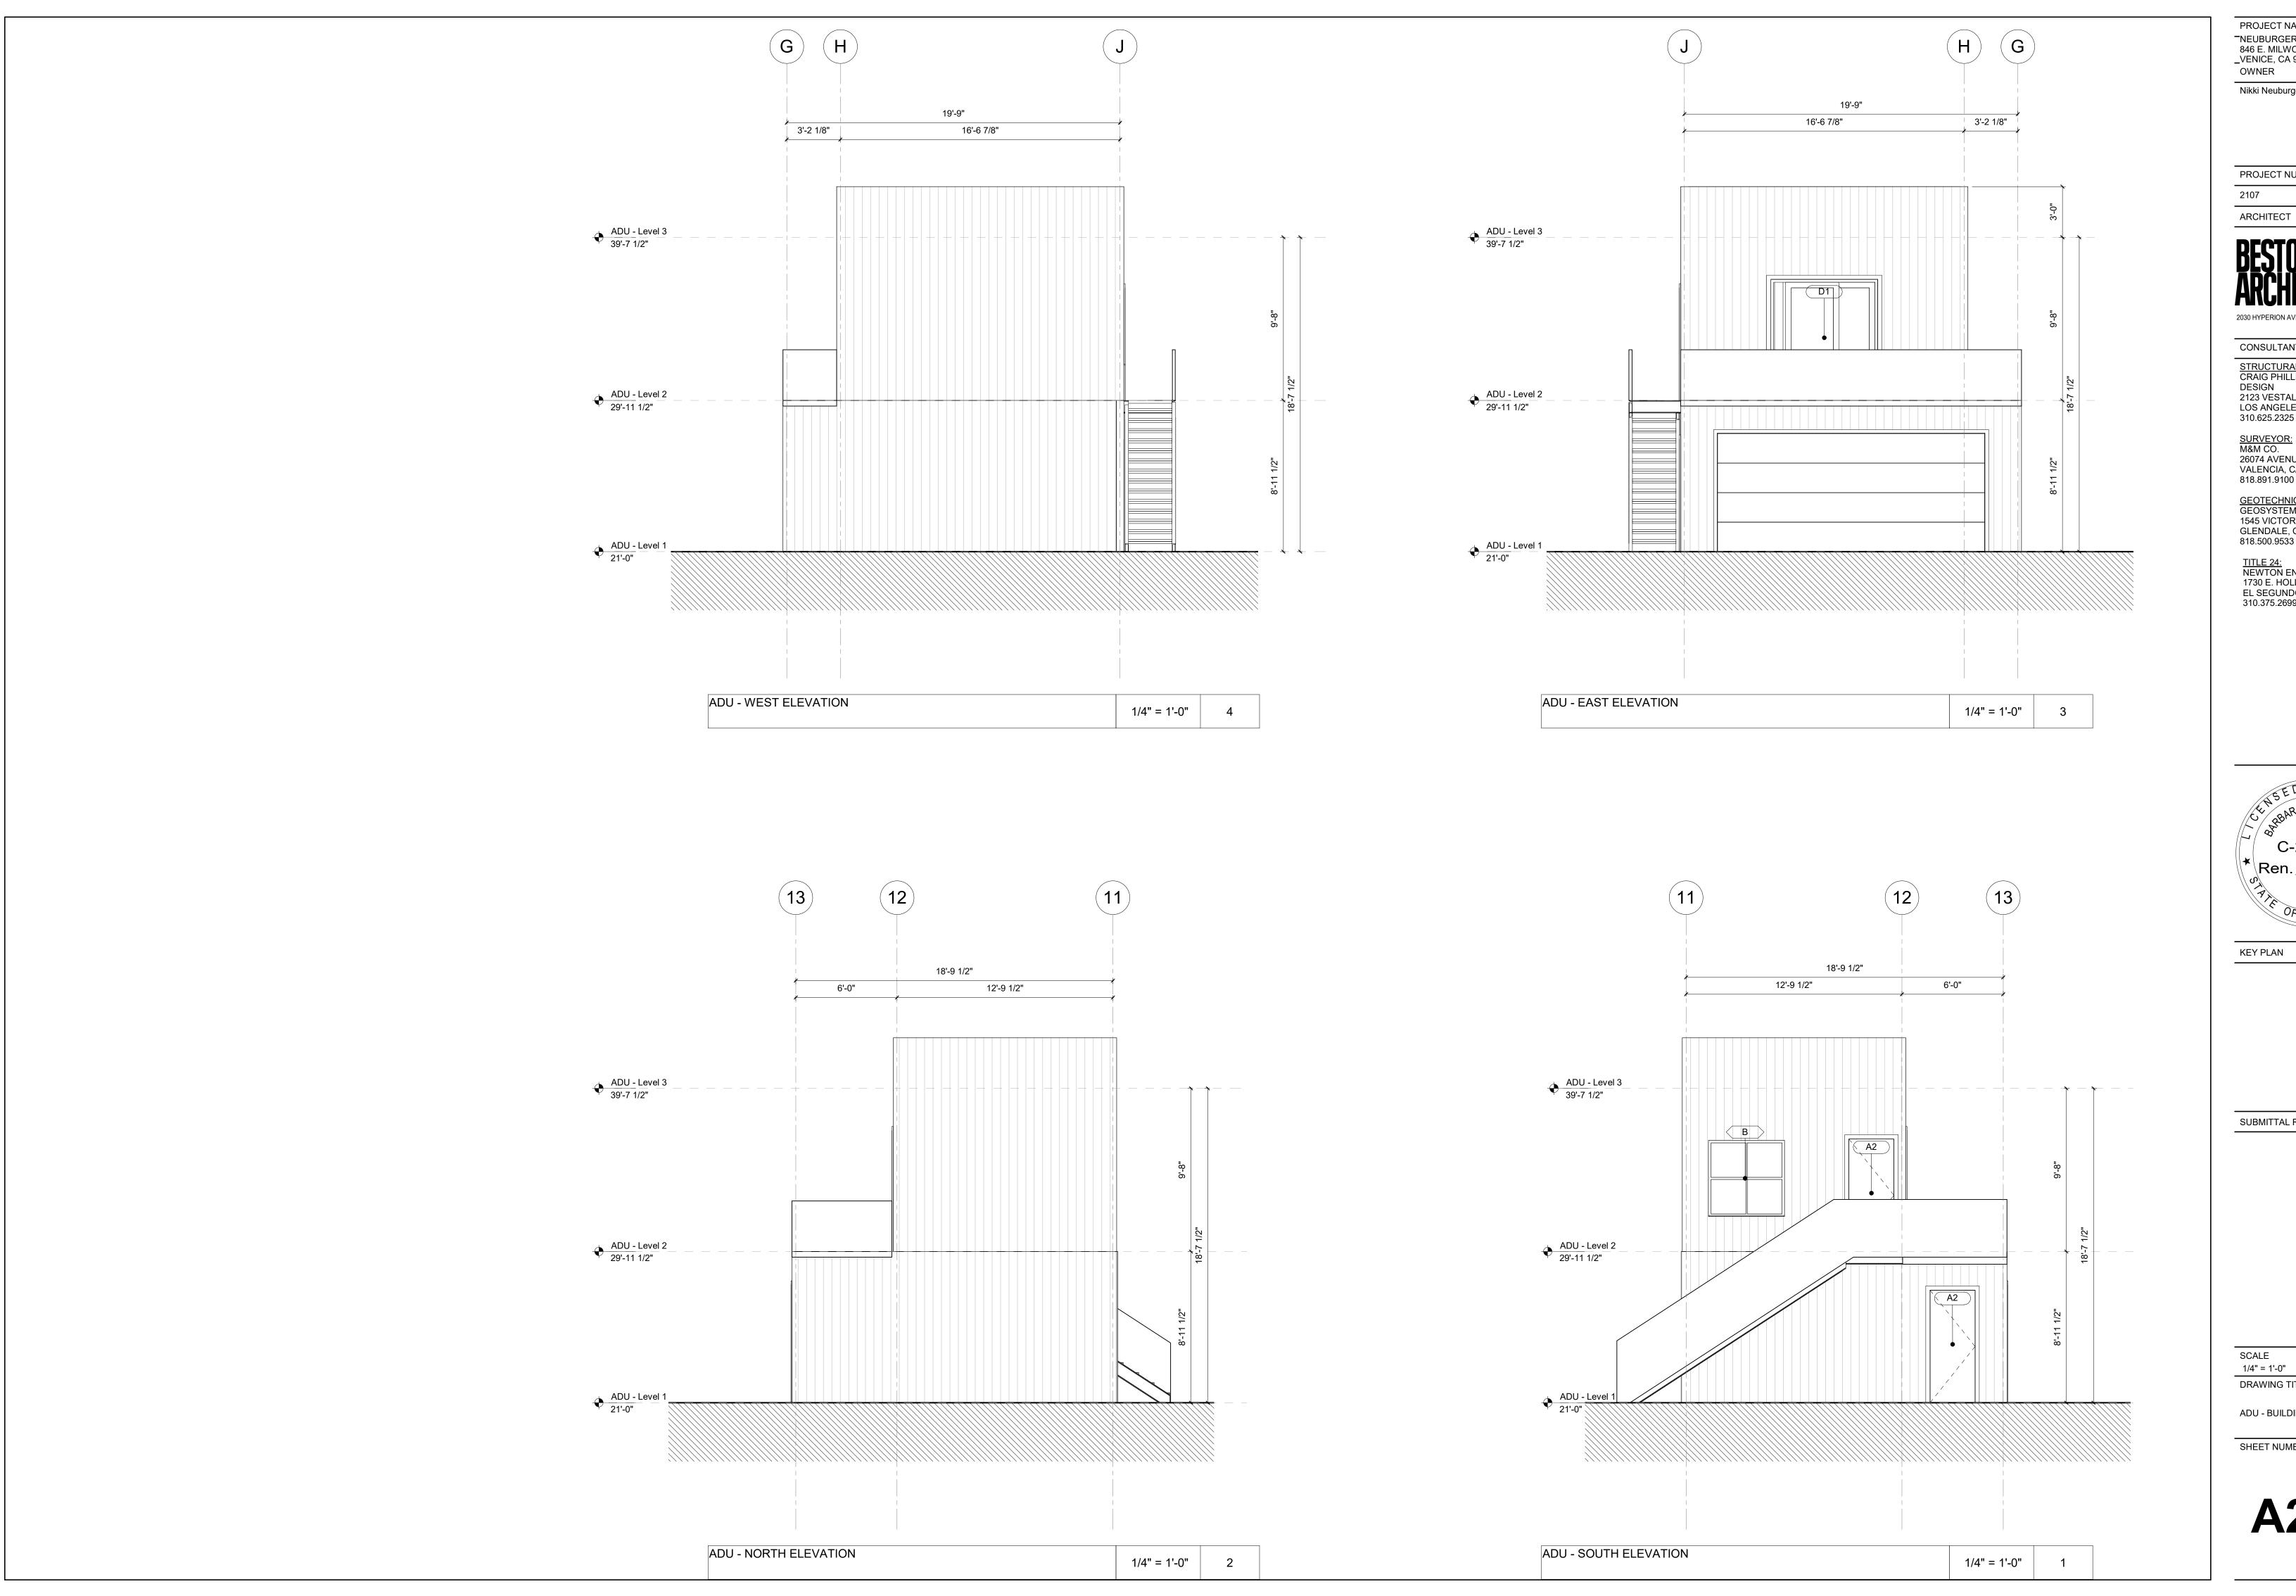
BUILDING ELEVATIONS

SHEET NUMBER

1/4" = 1'-0"

A201



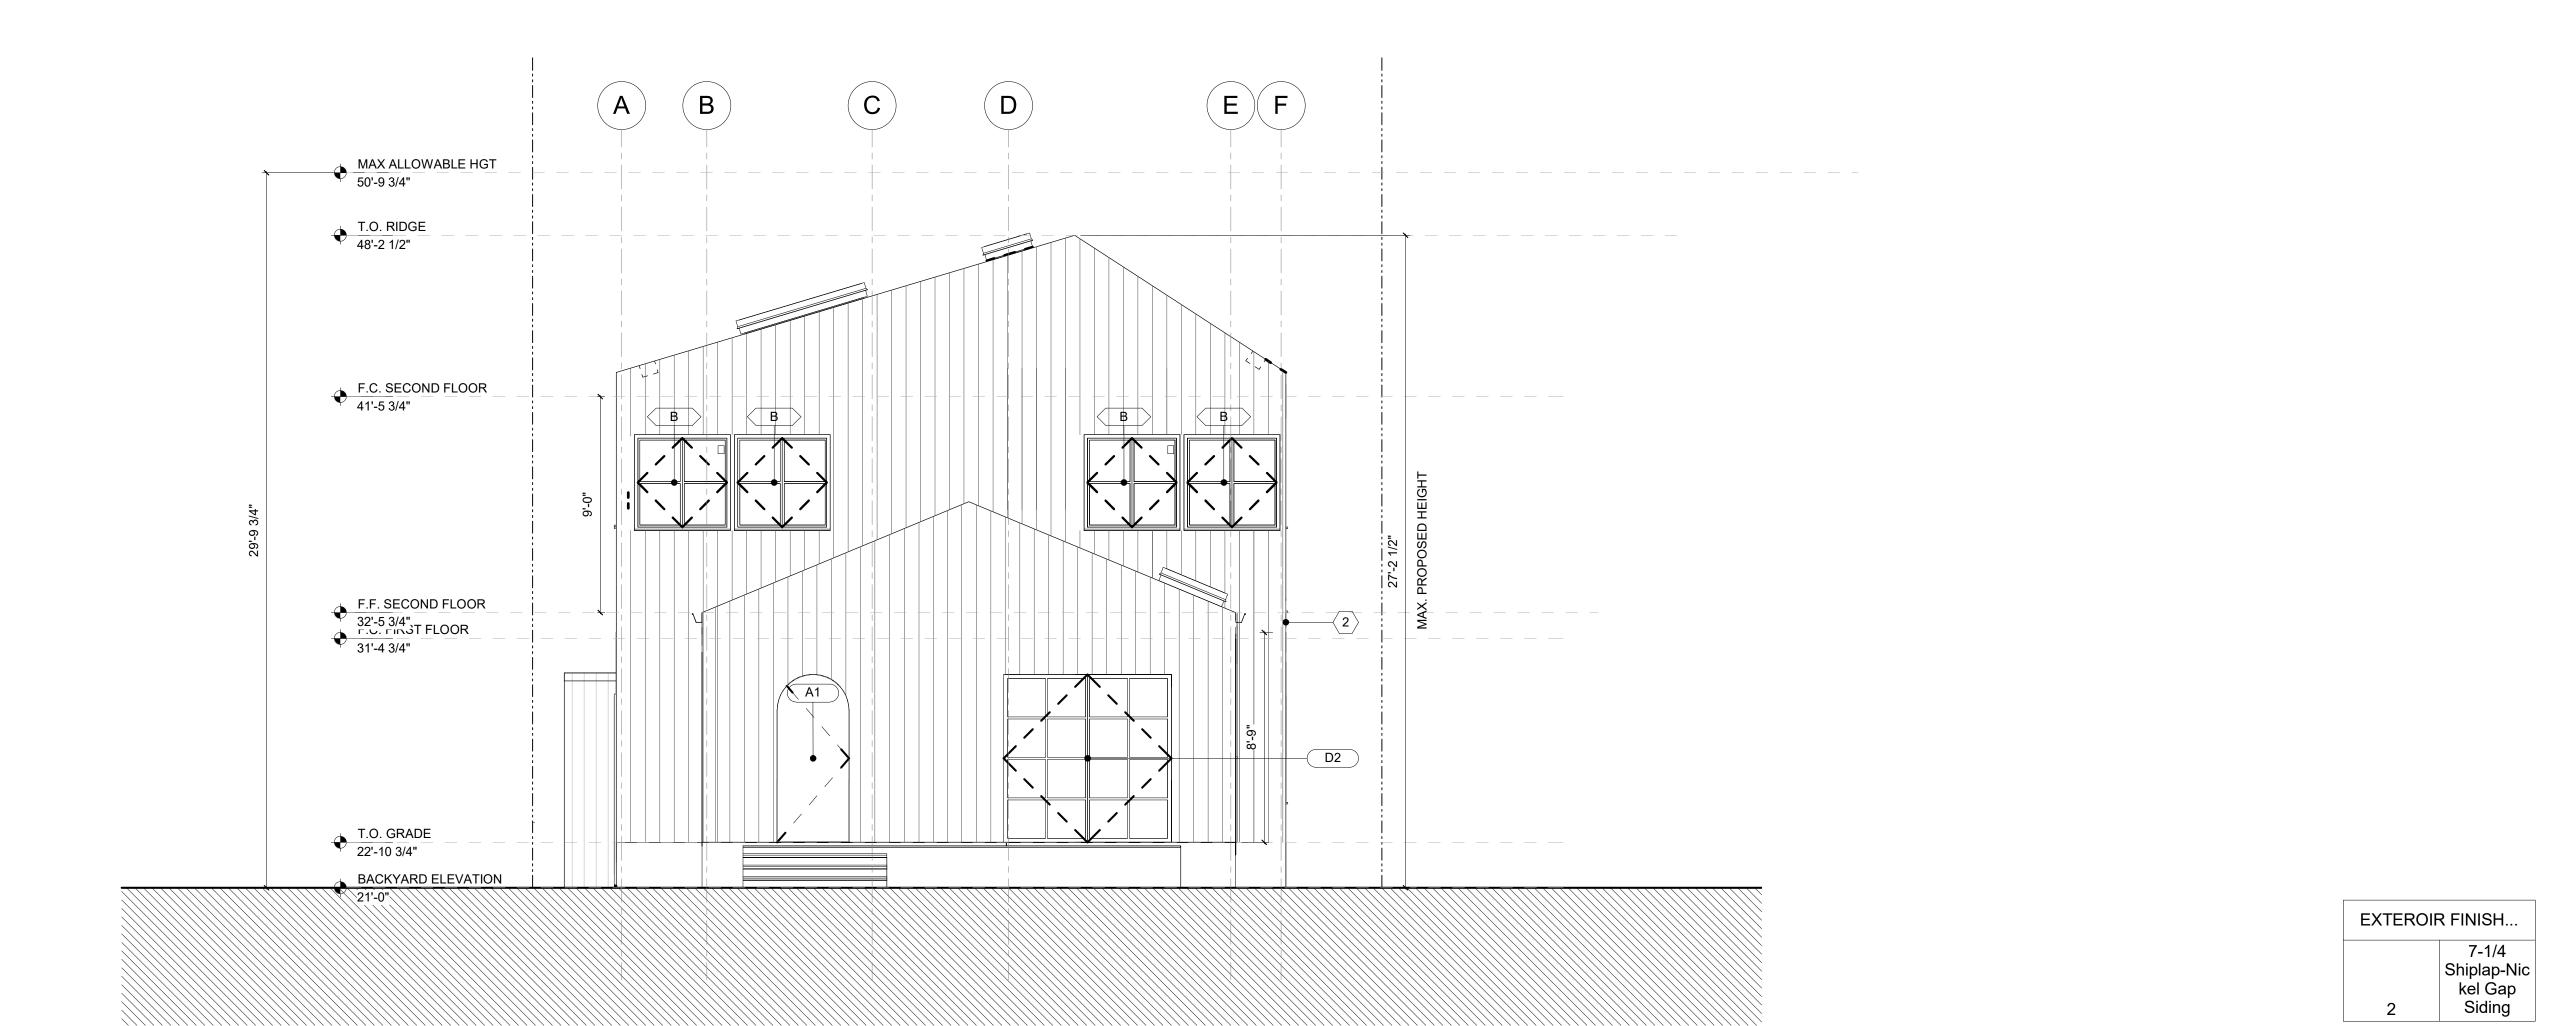

PROJECT NAME NEUBURGER RESIDENCE 846 E. MILWOOD AVE _VENICE, CA 90291_____

Nikki Neuburger

PROJECT NUMBER

2030 HYPERION AVE | LOS ANGELES, CA | 90027 323-666-9399

CONSULTANTS

STRUCTURAL ENGINEER:
CRAIG PHILLIPS ENGINEERING &
DESIGN
2123 VESTAL AVENUE
LOS ANGELES, CA 90026
310.625.2325

SURVEYOR: M&M CO. 26074 AVENUE HALL, SUITE 12 VALENCIA, CA 91355 818.891.9100

GEOTECHNICAL ENGINEER: GEOSYSTEMS 1545 VICTORY BLVD. 2ND FLOOR GLENDALE, CA 91201 818.500.9533

TITLE 24: NEWTON ENERGY 1730 E. HOLLY AVE, SUITE 755 EL SEGUNDO, CA 90245 310.375.2699




SUBMITTAL RECORD

SCALE

1/4" = 1'-0" DRAWING TITLE

ADU - BUILDING ELEVATIONS

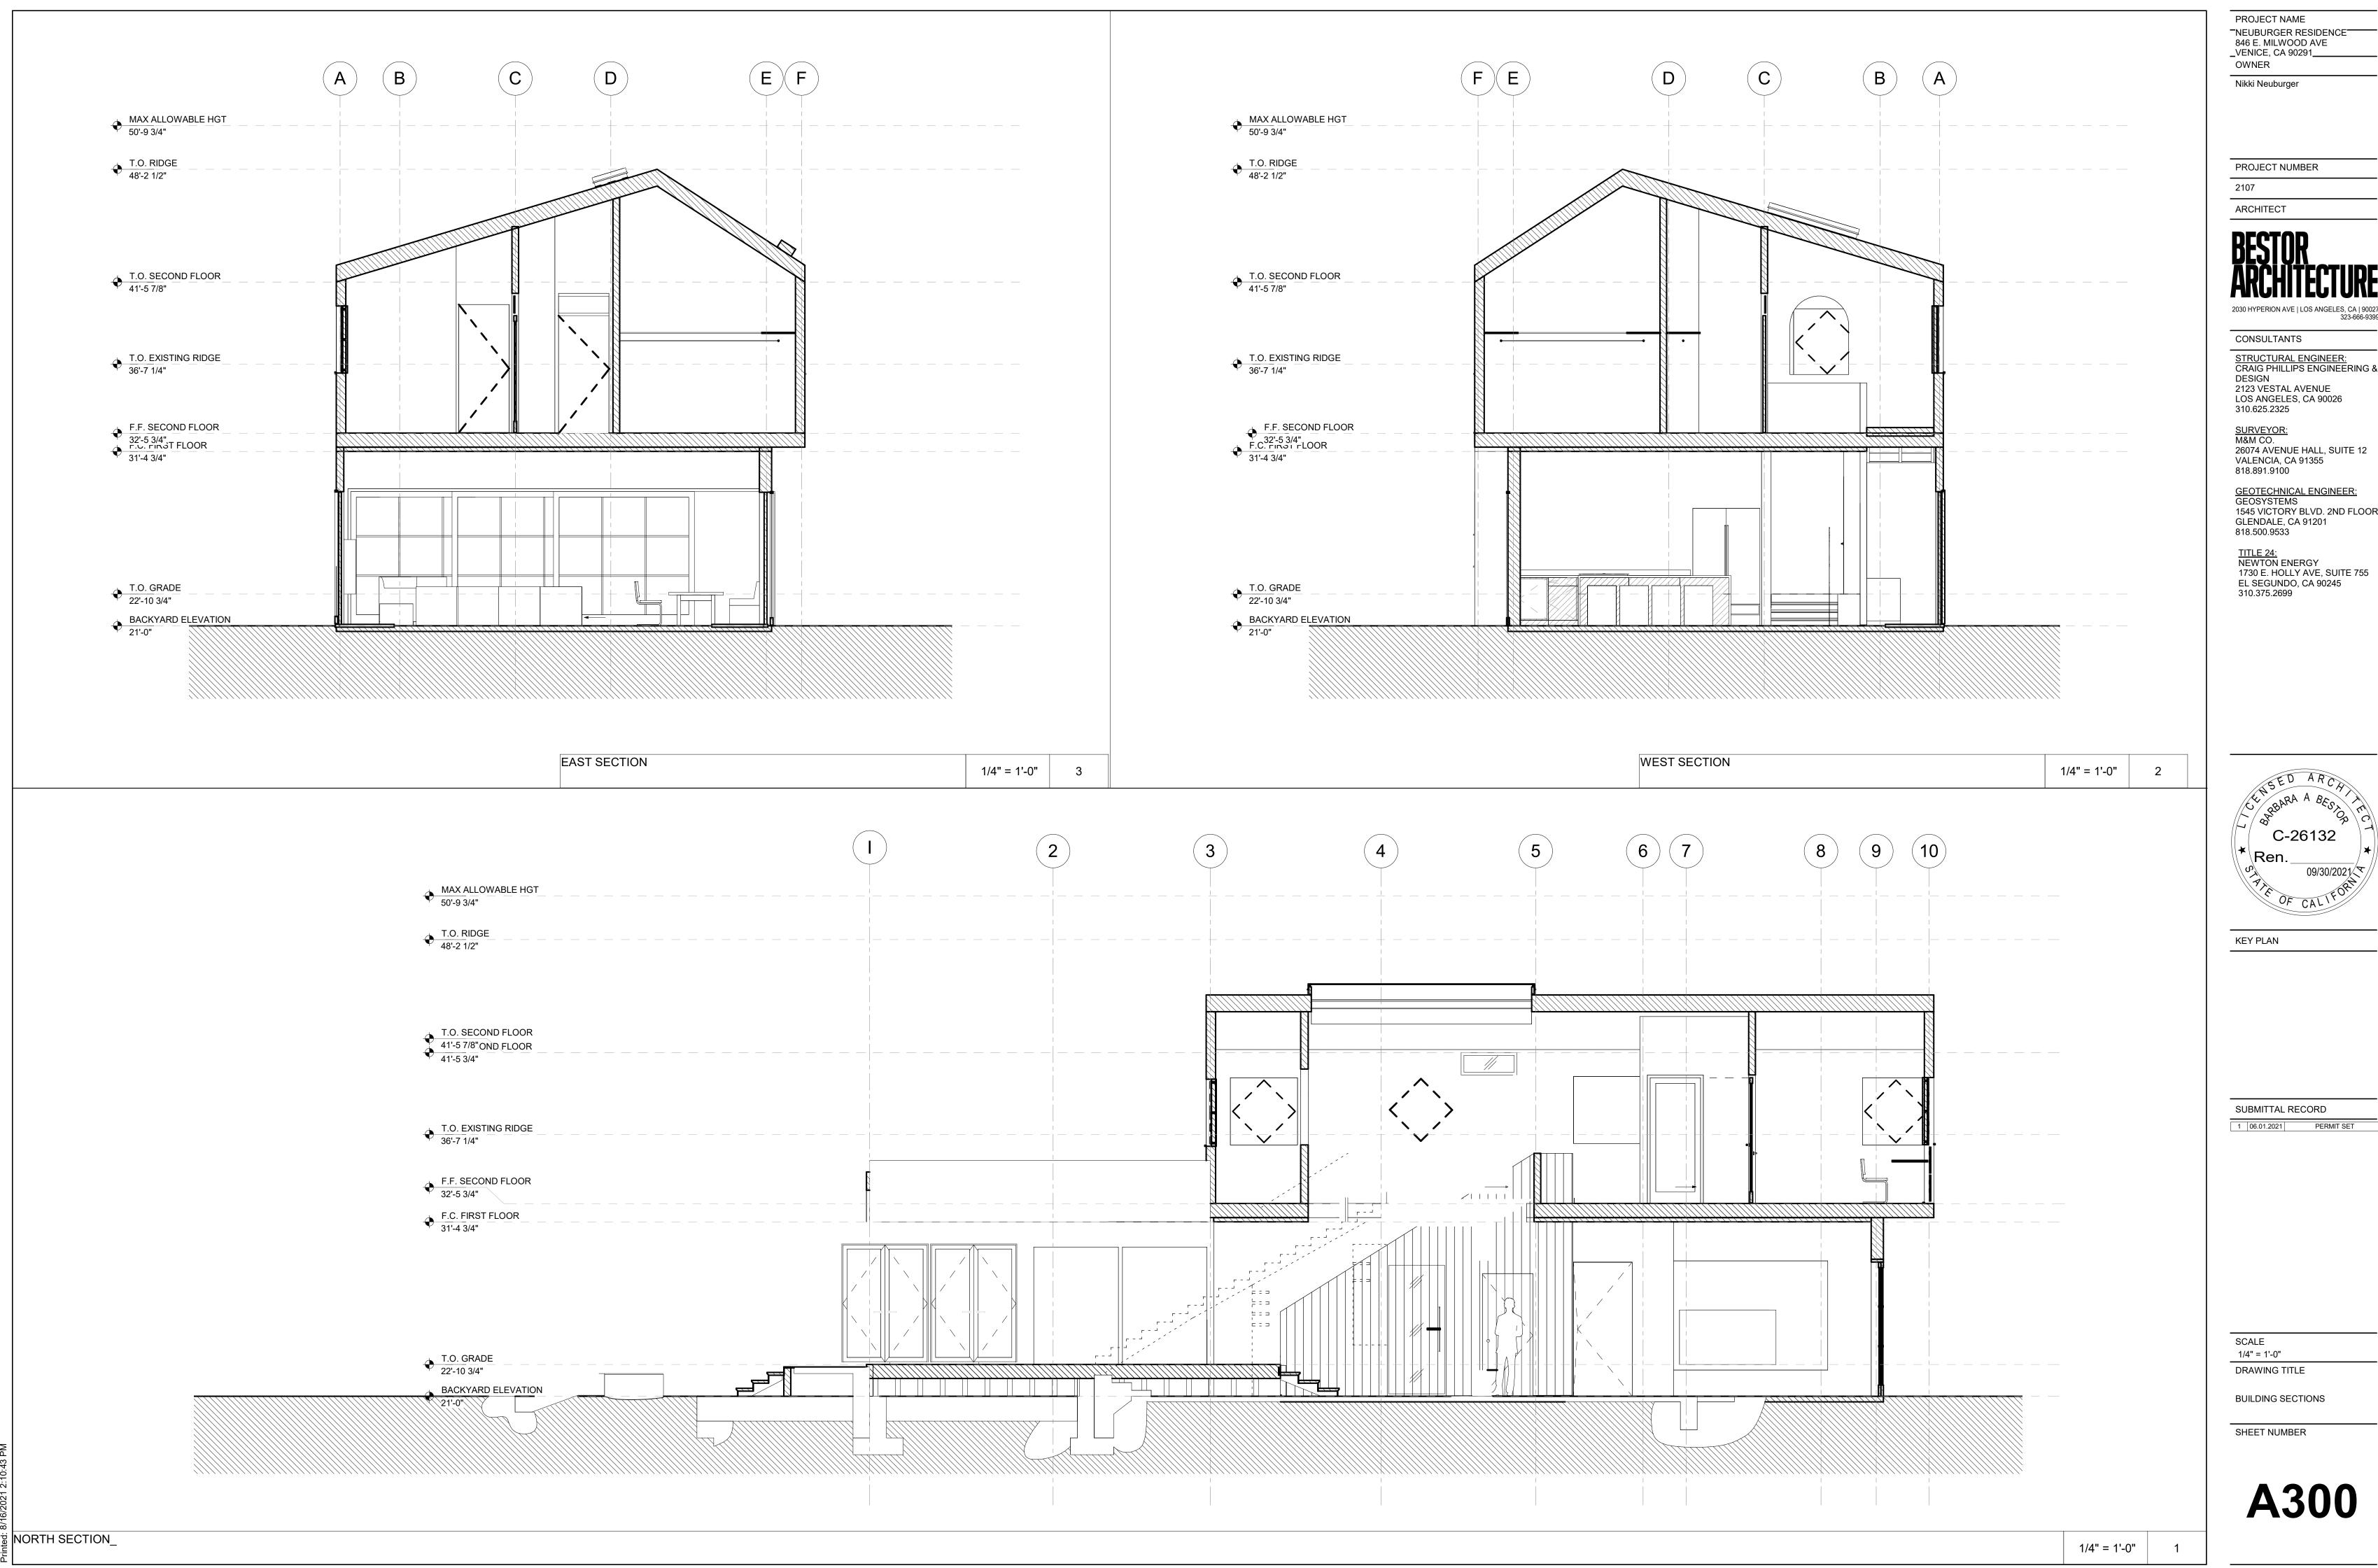

PROJECT NAME NEUBURGER RESIDENCE 846 E. MILWOOD AVE _VENICE, CA 90291_____

Nikki Neuburger

PROJECT NUMBER

2030 HYPERION AVE | LOS ANGELES, CA | 90027 323-666-9399

CONSULTANTS

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CRAIG PHILLIPS ENGINEERING &
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2123 VESTAL AVENUE
LOS ANGELES, CA 90026
310.625.2325

GEOTECHNICAL ENGINEER: GEOSYSTEMS 1545 VICTORY BLVD. 2ND FLOOR GLENDALE, CA 91201 818.500.9533

TITLE 24: NEWTON ENERGY 1730 E. HOLLY AVE, SUITE 755 EL SEGUNDO, CA 90245 310.375.2699

C-26132

KEY PLAN

SUBMITTAL RECORD PERMIT SET

1/4" = 1'-0"

BUILDING SECTIONS